

HORIZ, SIDING -

T/ SECOND FLOOR

FIRST FLOOR €


T/SLAB

OPT FLEX SIDE BAY

FRONT ELEVATION

ELEVATION DEPICTED IS A

REPRESENTATIVE SAMPLE WHICH WILL VARY BASED ON FOUNDATION TYPE AND

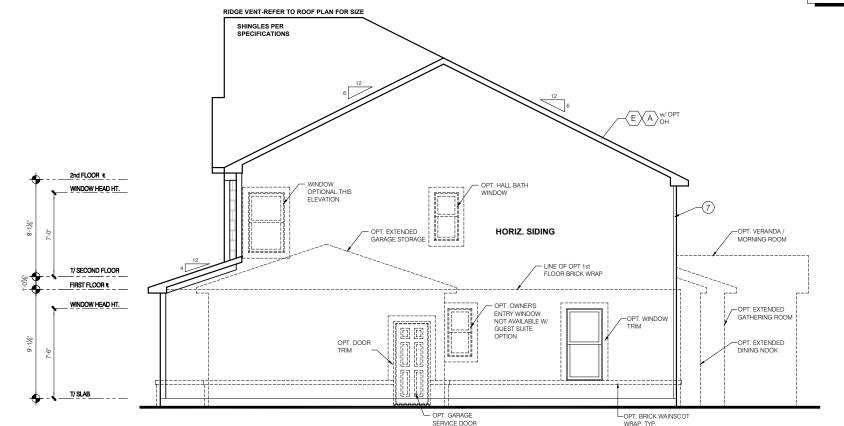

FRONT ELEVATION

ELEVATION "A" TRADITIONAL GARAGE SIDE ELEVATION

Drake FINAL SET 4/08/20

SERIES

PRESTIGE

= 6" TRIM (1x6, 5/4x6, 5" VINYL LINEAL)

(3) = 8" TRIM (1x8, 5/4x8, 7" VINYL LINEAL) **(4**) = 10" TRIM

= 12" TRIM (6) FRONT CORNERS = 5"TRIM PER DIVSION-SEE SPECS

(7) REAR CORNERS = 3"TRIM PER DIMISION - SEE SPECS

DIVISION NOTE:

TYPICAL EXTERIOR TRIM FINISH

AS A GUIDE FOR TRIM SIZES. ALL TRIM NOTED ON THE ELEVATIONS IS NOMINAL. SEE SPECIFICATIONS FOR TRIM

1 = 4" TRIM (1x4, 5/4x4, 3½" VINYL LINEAL)

TRIM NOTED ON THE ELEVATIONS IS PROVIDED SOLELY

IT IS THE RESPONSIBILITY OF EACH DIVISION TO DETERMINE, AT A DIVISIONAL LEVEL AS WELL AS COMMUNITY SPECIFIC LEVEL. THE DESIRED FINISH REQUIREMENTS OF SPECIFIC TRIM PIECES; WHETHER PAINTED, VINYL, OR ALUMINUM WRAPPED.

WINDOW GRID NOTE:

- FRONT WINDOW GRIDS ARE STANDARD - SIDE AND REAR GRIDS ARE OPTIONAL PER
- *GRID PATTERNS TO MATCH FRONT ELEVATION

GRADING REQUIREMENTS.

SIDING PER PLAN -


ALUMINUM COIL COIL AND THROUGH FLASHING FLASHING TUCKED AND TAPED UNDER HOUSE SILL TO BE A MINIMUM OF 15° SLOPE (BRICK OR STONE) WEEP HOLES @ 2 THROUGH FLASHING (TUCK UNDER COIL


HOUSE WRAP

BRICK WAINSCOT DETAIL

Job #: LSP Date: X/X/XX LSP By: LSP Rev neet Title Front And Garao

Elevations

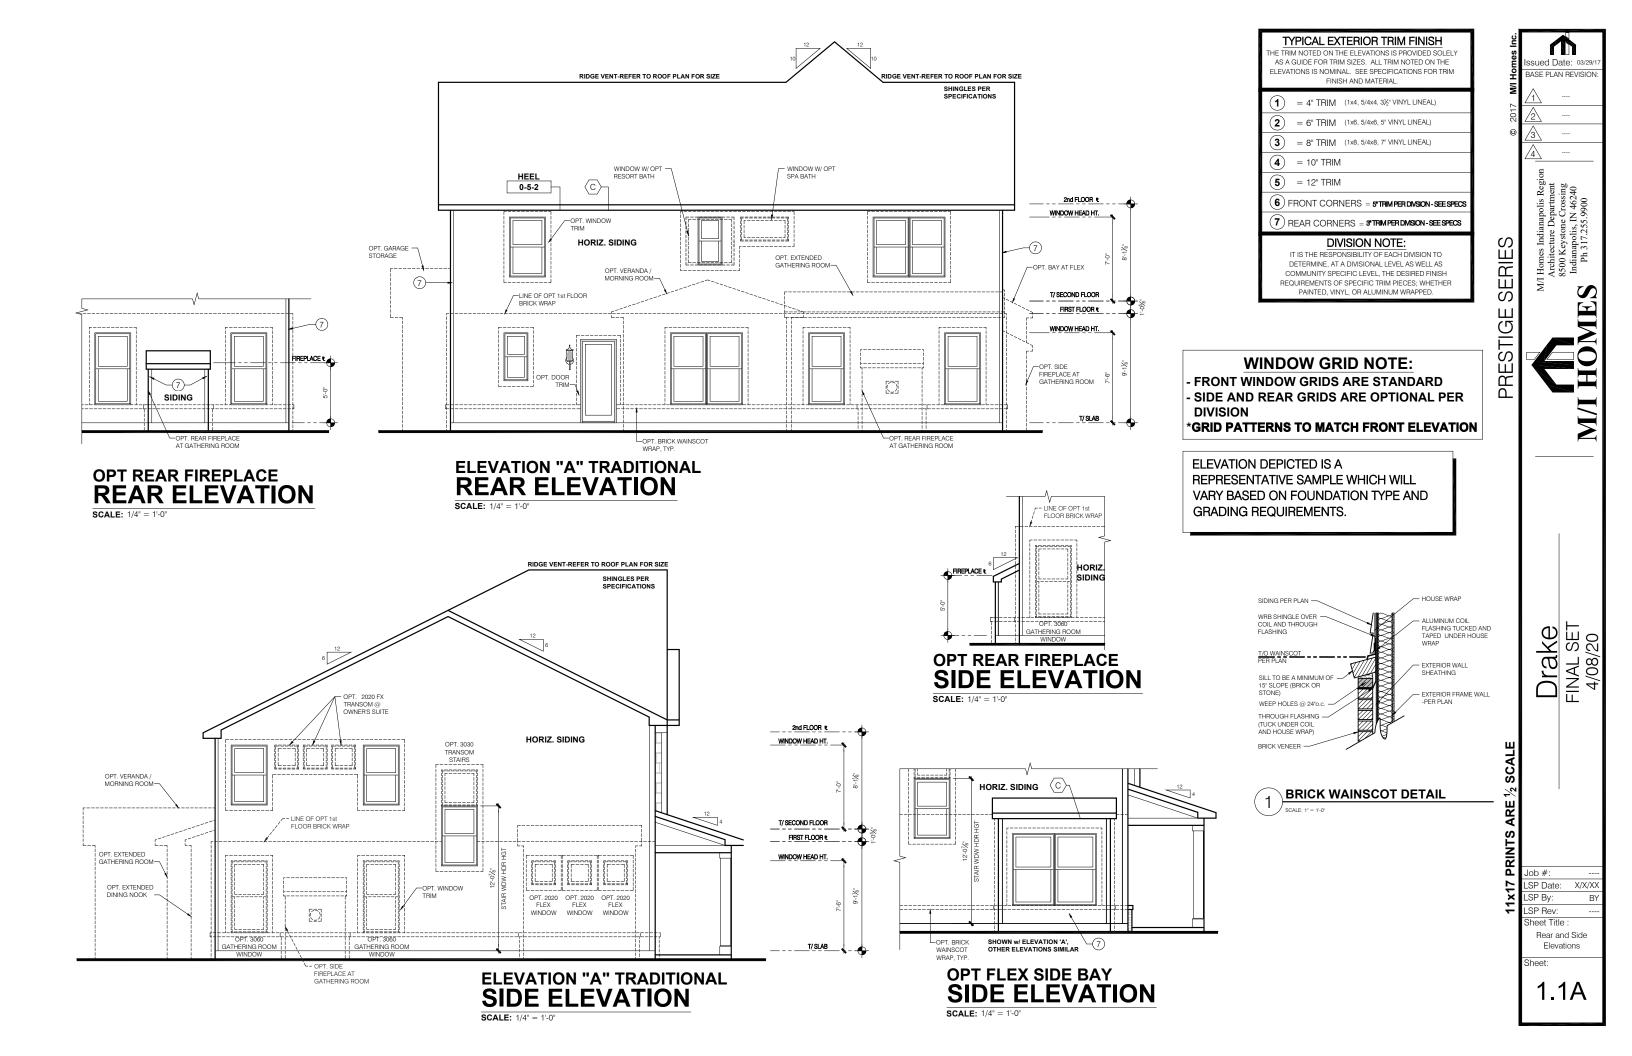

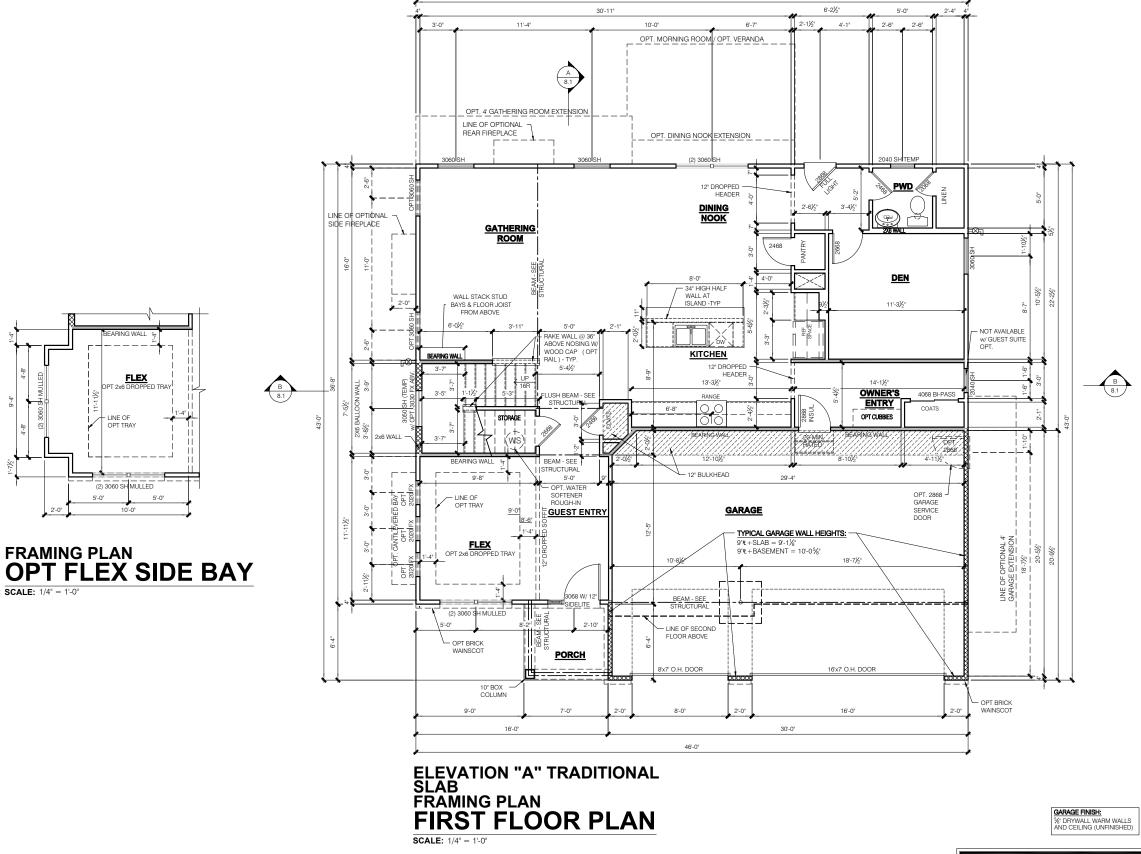

WINDOW/DOOR FRAMING NOTE:

WINDOW AND DOOR FRAMING TO INCLUDE (1) JACK STUD AND (1) KING STUD EA. SIDE U.N.O. SEE DETAILS 1 & 2 SHEET D3.1

GARAGE DRYWALL NOTE:

ALL GARAGE /HOUSE COMMON WALLS, CEILINGS, BEAMS, COLUMNS THAT SUPPORT FLOOR-CEILING ASSEMBLY ABOVE TO HAVE

TYPICAL STUD WALL SIZES PER LOCATION:

- EXTERIOR WALLS AT CONDITIONED SPACES ARE 2x6s W/ χ^2 NOMINAL SHEATHING U.N.O. (4°). **STUDS @ 16° O.C. U.N.O.** GARAGE/HOUSE COMMON WALLS ARE 2x6s U.N.O. (5½°) STUDS **@ 24° O.C. U.N.O.**
- GARAGE EXTERIOR WALLS ARE 2x6's W/ ½" NOMINAL SHEATHING U.N.O. (4") STUDS @ 16" O.C.
- WALLS ADJACENT TO ATTIC SPACES ARE 2x4's W/ $\frac{1}{2}$ " NOMINAL SHEATHING U.N.O. (6"). STUDS @ 16" O.C. U.N.O.

EXTERIOR WALLS ARE SHOWN WITH $1/2^\circ$ NOMINAL SHEATHING WHICH IS HELD FLUSH WITH THE OUTSIDE OF THE FOUNDATION


NOTE:
- INDICATES WALL HEIGHTS LOWER
THAN STANDARD HEIGHT- AS NOTED - INDICATES WALL HEIGHTS HIGHER
THAN STANDARD HEIGHT- AS NOTED - INDICATES SLOPED WALLS - AS NOTED - INDICATES INTERIOR LOAD BEARING WALLS, FRAME 16" O.C.(2x4) 24" O.C.(2x6) W/ DBL. TOP PLATE ALL OTHER WALLS ARE 9-1 1/8" HIGH ALL STRUCTURAL HEADERS ARE (2) 2x6 -UNLESS NOTED OTHERWISE. ALL POINT LOADS TO BE BLOCKED SOLID TO FINAL SUPPORT MEMBER OR Drake FINAL SET 4/08/20 STAIRS FROM 1st TO 2nd FLOOR ARE TO BE 16 RISERS INDICATES (3) JACK STUDS TYP.
 UNLESS NOTED (#2, SPF) $\begin{tabular}{ll} $\#$ \hline & - \text{INDICATES QUANTITY OF NON-STD.} \\ & \text{STUDS } (\#2 \text{ SPF}) \\ \end{tabular}$ - INDICATES QUANTITY OF RIPPED LVL (2650 Fb-1.9E)or PSL STUDS, WIDE BY WALL THICKNESS

SERIES

PRESTIGE

Job #: LSP Date: X/X/XX LSP By: SP Rev heet Title

1st Floor Plan - Slab

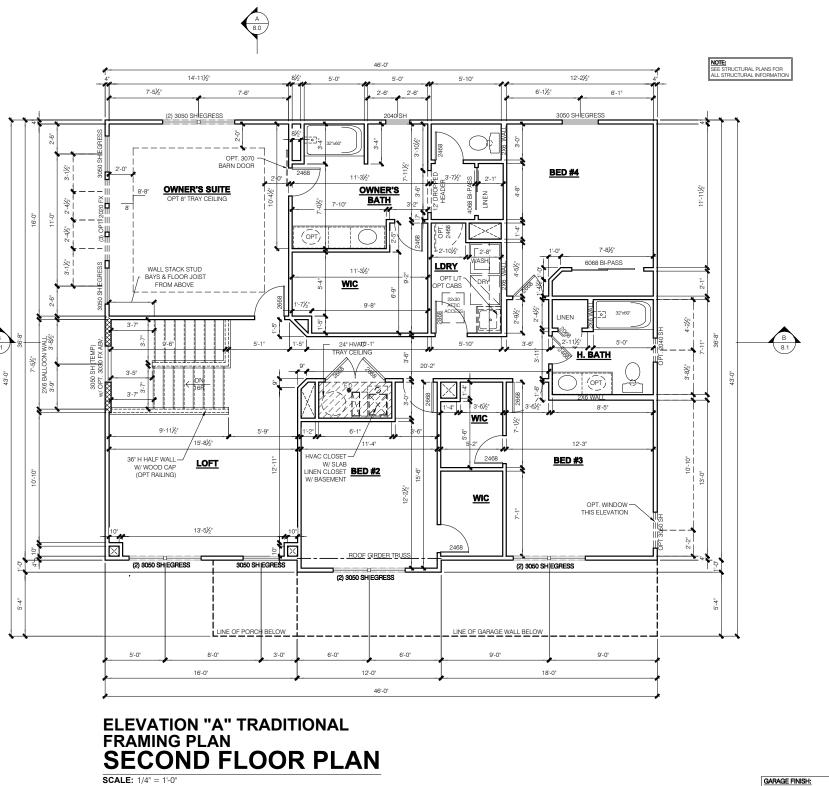

SCALE: 1/4" = 1'-0"

WINDOW/DOOR FRAMING NOTE:

WINDOW AND DOOR FRAMING TO INCLUDE (1) JACK STUD AND (1) KING STUD EA. SIDE U.N.O. SEE DETAILS 1 & 2 SHEET D3.1

GARAGE DRYWALL NOTE:

ALL GARAGE /HOUSE COMMON WALLS, CEILINGS, BEAMS, COLUMNS THAT SUPPORT FLOOR-CEILING ASSEMBLY ABOVE TO HAVE

TYPICAL STUD WALL SIZES PER LOCATION:

%" DRYWALL WARM WALLS AND CEILING (UNFINISHED)

- EXTERIOR WALLS AT CONDITIONED SPACES ARE 2x6s W/ ½* NOMINAL SHEATHING U.N.O. (4*). STUDS @ 16* O.C. U.N.O. GAMBAGE/HOUSE COMMON WALLS ARE 2x6's U.N.O. (5½*) STUDS @ 24* O.C. U.N.O.
- GARAGE EXTERIOR WALLS ARE 2x6's W/ ½" NOMINAL SHEATHING U.N.O. (4") STUDS @ 16" O.C. WALLS ADJACENT TO ATTIC SPACES ARE 2x4's W/ 2" NOMINAL SHEATHING U.N.O. (6"). **STUDS @ 16" O.C. U.N.O.**
- EXTERIOR WALLS ARE SHOWN WITH 1/2 NOMINAL SHEATHING WHICH IS HELD FLUSH WITH THE OUTSIDE OF THE FOUNDATION

Drake FINAL SET 4/08/20 PRINTS Job #: LSP Date:

SERIES **PRESTIGE**

BASE PLAN REVISION


NOTE:
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THAN STANDARD HEIGHT- AS NOTE - INDICATES WALL HEIGHTS HIGHER
THAN STANDARD HEIGHT- AS NOTED

- INDICATES SLOPED WALLS - AS NOTED - INDICATES INTERIOR LOAD BEARING WALLS, FRAME 16° O.C.(2x4) 24° O.C.(2x6) W/ DBL. TOP PLATE

- ALL OTHER WALLS ARE 9-1 1/8" HIGH ALL STRUCTURAL HEADERS ARE (2) 2x6 -UNLESS NOTED OTHERWISE. ALL POINT LOADS TO BE BLOCKED SOLID TO FINAL SUPPORT MEMBER OR
- FOUNDATION. STAIRS FROM 1st TO 2nd FLOOR ARE TO BE
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- INDICATES QUANTITY OF RIPPED LVL (2650 Fb-1.9E) or PSL STUDS, WIDE BY WALL THICKNESS

X/X/XX LSP By: SP Rev

neet Title 2nd Floor Plan

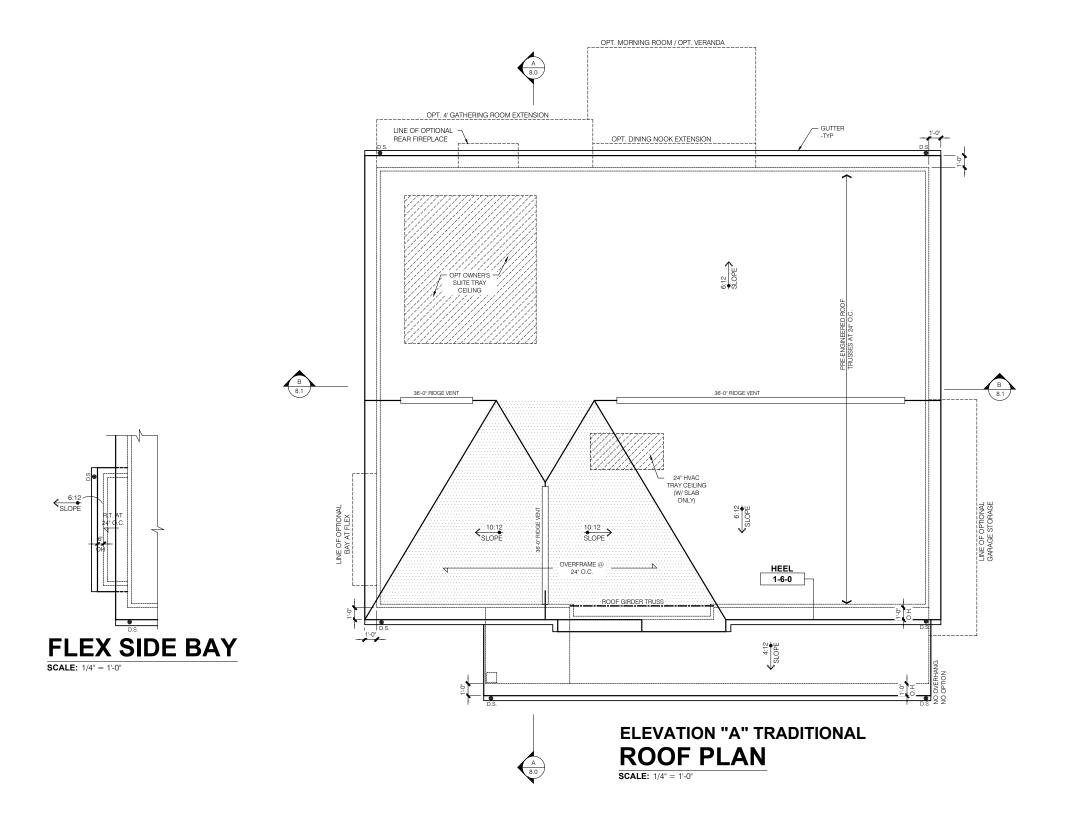

1. THIS LAYOUT REPRESENTS DESIGN INTENT ONLY.
SUPPLIER IS TO PROVIDE FINAL TRUSS LAYOUT AND ENGINEERED DRAWINGS FOR APPROVAL OF MI HOMES.

- 2. TRUSS DRAWINGS STAMPED BY AN ENGINEER REGISTERED WITH THE STATE OF PERMIT, ALONG WITH LAYOUT SHEET, TO BE PROVIDED TO THE BUILDING INSPECTOR FOR FRAMING INSPECTION.
- 3. ALL TRUSS CONNECTIONS TO BE PROVIDED BY THE TRUSS MANUFACTURER.
- 4. "I"- JOIST RAFTER DESIGN BASED ON LPI 20PLUS (1.5E)
 I-JOISTS BY LOUISANA PACIFIC U.N.O.
- 5. ALL ROOF TRUSSES AND RAFTERS ARE TO BE CONNECTED TO DOUBLE TOP PLATE W/ A MINIMUM OF (1) H2.5A BY SIMPSON OR EQUAL U.N.O.
- GIRDER TRUSSES ARE TO HAVE HOLD DOWNS TO RESIST THE REQUIRED UPLIFT AS SHOWN ON TRUSS MANUFACTUERS DRAWINGS.
- 7. ALL DIMENSIONAL LUMBER TO BE SYP #2 OR BETTER UNLESS NOTED OTHERWISE.

PRESTIGE SERIES

ASE PLAN REVISION


Drake FINAL SET 4/08/20

PRINTS ARE 1/2 S


Job #: ---LSP Date: X/X/XX
LSP By: BY
LSP Rev: ----

Sheet Title : Roof Plan - Base Roof

Sheet:

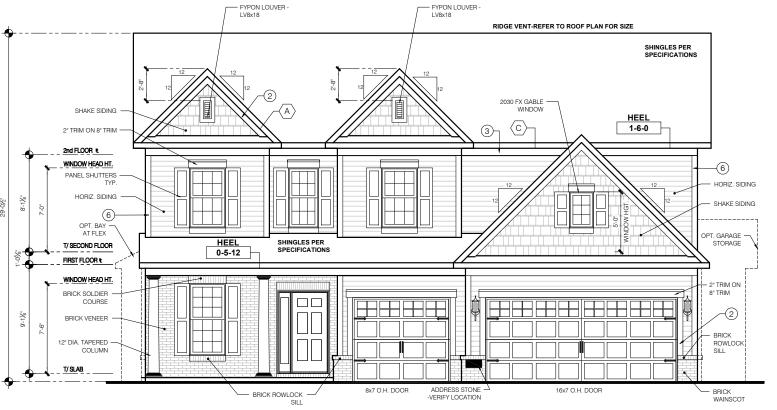

ELEVATION "B" COLONIAL REVIVAL FRONT ELEVATION

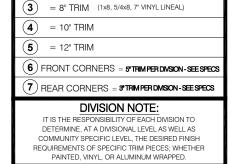

TYPICAL EXTERIOR TRIM FINISH TRIM NOTED ON THE ELEVATIONS IS PROVIDED SOLELY AS A GUIDE FOR TRIM SIZES. ALL TRIM NOTED ON THE

ELEVATIONS IS NOMINAL. SEE SPECIFICATIONS FOR TRIM

= 6" TRIM (1x6, 5/4x6, 5" VINYL LINEAL)

1 = 4" TRIM (1x4, 5/4x4, 3½" VINYL LINEAL)

WINDOW GRID NOTE:

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SIDING PER PLAN -


COIL AND THROUGH FLASHING

WEEP HOLES @ 24 THROUGH FLASHING

(TUCK UNDER COIL AND HOUSE WRAP)

SILL TO BE A MINIMUM OF 15° SLOPE (BRICK OR STONE)

BRICK WAINSCOT DETAIL

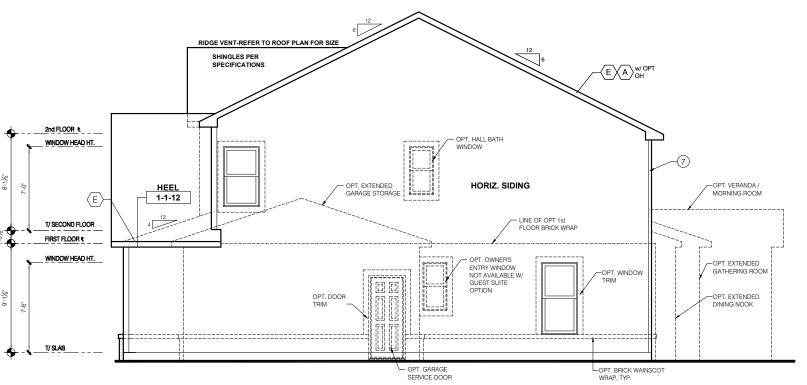

ELEVATION "B" COLONIAL REVIVAL GARAGE SIDE ELEVATION

Job #: LSP By: LSP Rev

LSP Date: X/X/XX neet Title

Front And Garao Elevations

1.0B

T/ SECOND FLOOF 12" DIA. TAPERED COLUMN T/ SLAB

OPT FLEX SIDE BAY FRONT ELEVATION

HOUSE WRAP

ALUMINUM COIL


FLASHING TUCKED AND

TAPED UNDER HOUSE

SERIES

PRESTIGE

Drake FINAL SET 4/08/20

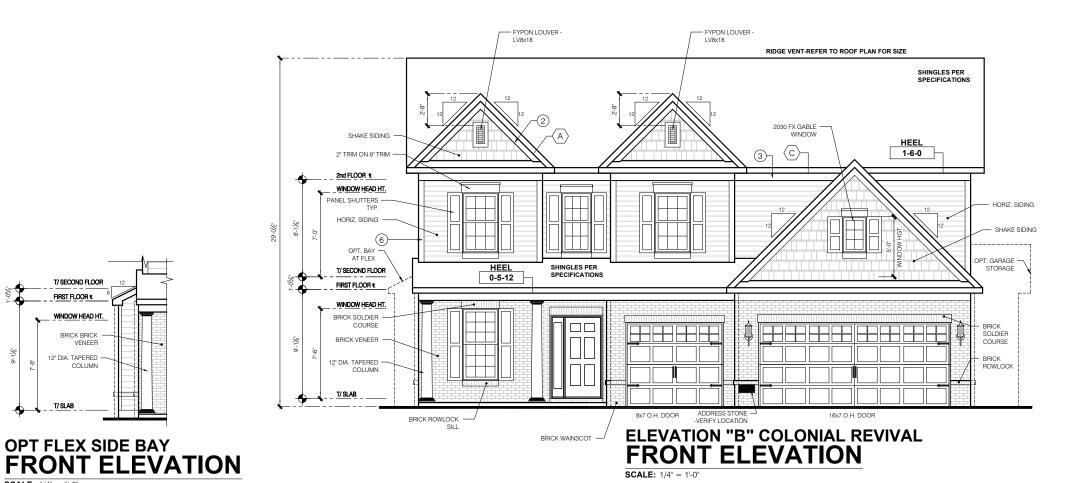

T/ SECOND FLOOR

WINDOW HEAD HT.

BRICK BRICK VENEER

COLUMN


OPT FLEX SIDE BAY

12" DIA. TAPERED

T/SLAB

SCALE: 1/4" = 1'-0"

FIRST FLOOR &

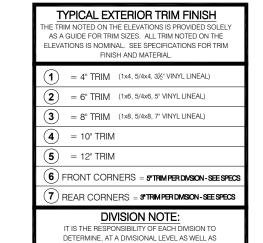


COMMUNITY SPECIFIC LEVEL. THE DESIRED FINISH REQUIREMENTS OF SPECIFIC TRIM PIECES; WHETHER PAINTED, VINYL, OR ALUMINUM WRAPPED.

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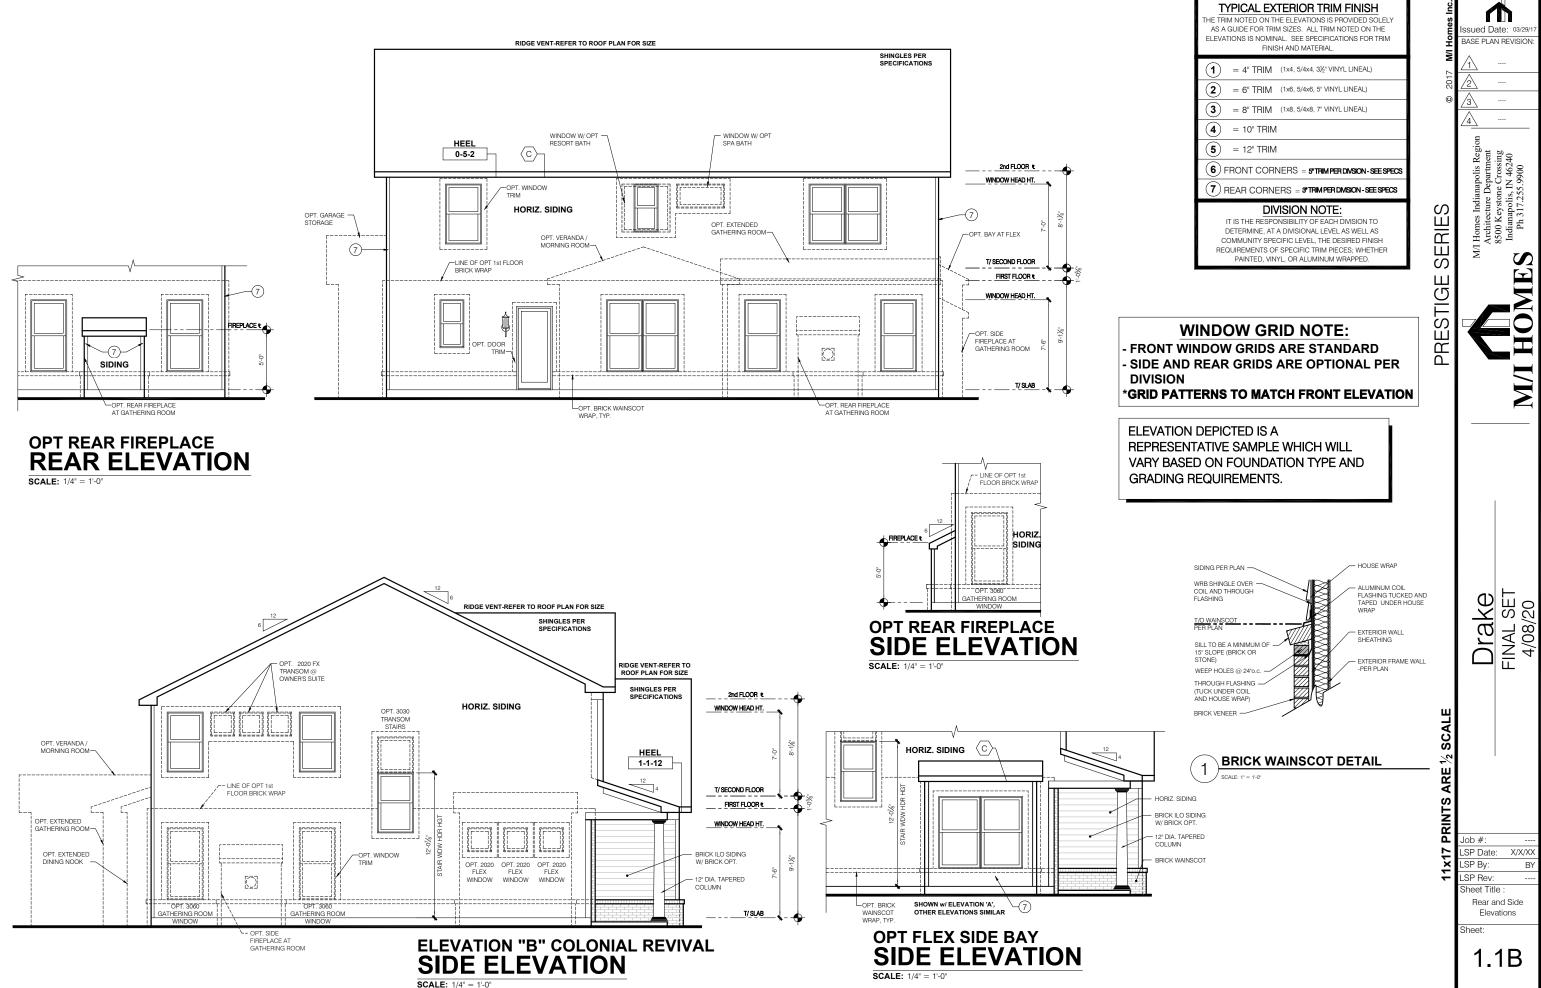
Drake FINAL SET 4/08/20

SERIES


PRESTIGE

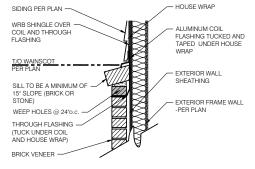Job #: LSP Date: X/X/XX LSP By: LSP Rev neet Title Front Elevation Brick Garage

> heet. 1.01B



X/X/XX

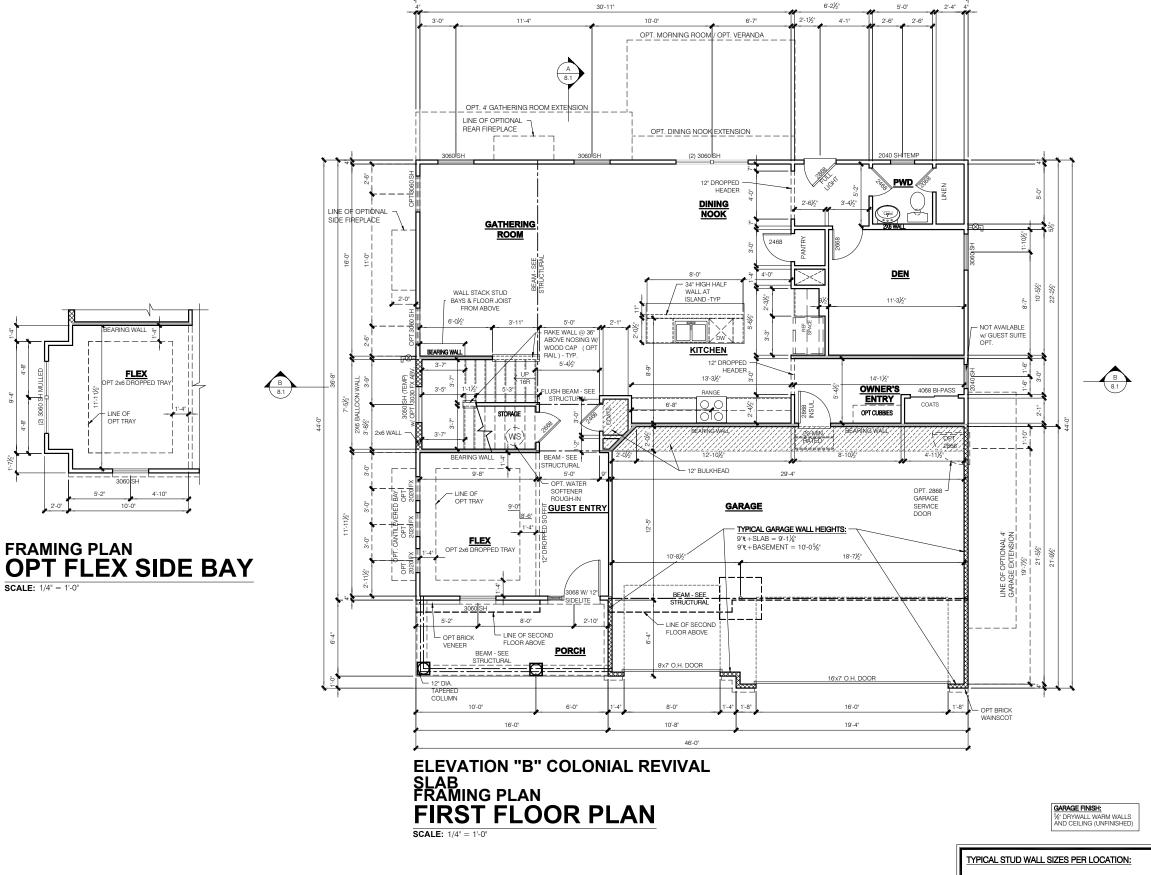

WINDOW/DOOR FRAMING NOTE:

WINDOW AND DOOR FRAMING TO INCLUDE (1) JACK

STUD AND (1) KING STUD EA. SIDE U.N.O.

SEE DETAILS 1 & 2 SHEET D3.1

EXTERIOR WALLS AT CONDITIONED SPACES ARE 2x6's W/ ½* NOMINAL SHEATHING U.N.O. (4*). STUDS @ 16* O.C. U.N.O. GARAGE/HOUSE COMMON WALLS ARE 2x6's U.N.O. (5½*) STUDS @ 24* O.C. U.N.O.

GARAGE DRYWALL NOTE:

ALL GARAGE /HOUSE COMMON WALLS, CEILINGS, BEAMS, COLUMNS THAT SUPPORT FLOOR-CEILING ASSEMBLY ABOVE TO HAVE

GARAGE EXTERIOR WALLS ARE 2x6's W/ ½" NOMINAL SHEATHING U.N.O. (4") STUDS @ 16" O.C. WALLS ADJACENT TO ATTIC SPACES ARE 2x4's W/ $\frac{1}{2}$ " NOMINAL SHEATHING U.N.O. (6"). STUDS @ 16" O.C. U.N.O.

EXTERIOR WALLS ARE SHOWN WITH $1/2^\circ$ NOMINAL SHEATHING WHICH IS HELD FLUSH WITH THE OUTSIDE OF THE FOUNDATION

 INDICATES (3) JACK STUDS TYP.
 UNLESS NOTED (#2, SPF) $\begin{tabular}{ll} $\#$ \hline & - \text{INDICATES QUANTITY OF NON-STD.} \\ & \text{STUDS } (\#2 \text{ SPF}) \\ \end{tabular}$ - INDICATES QUANTITY OF RIPPED LVL (2650 Fb-1.9E)or PSL STUDS, WIDE BY WALL THICKNESS

NOTE:
- INDICATES WALL HEIGHTS LOWER
THAN STANDARD HEIGHT- AS NOTE

- INDICATES WALL HEIGHTS HIGHER
THAN STANDARD HEIGHT- AS NOTED

- INDICATES INTERIOR LOAD BEARING WALLS, FRAME 16" O.C.(2x4) 24" O.C.(2x6) W/ DBL. TOP PLATE

ALL OTHER WALLS ARE 9-1 1/8" HIGH ALL STRUCTURAL HEADERS ARE (2) 2x6 -UNLESS NOTED OTHERWISE. ALL POINT LOADS TO BE BLOCKED SOLID TO FINAL SUPPORT MEMBER OR

STAIRS FROM 1st TO 2nd FLOOR ARE TO BE

- INDICATES SLOPED WALLS - AS NOTED

Job #: LSP Date: LSP By: SP Rev

SERIES


PRESTIGE

neet Title 1st Floor Plan - Slab

X/X/XX

Drake FINAL SET 4/08/20

4.0B

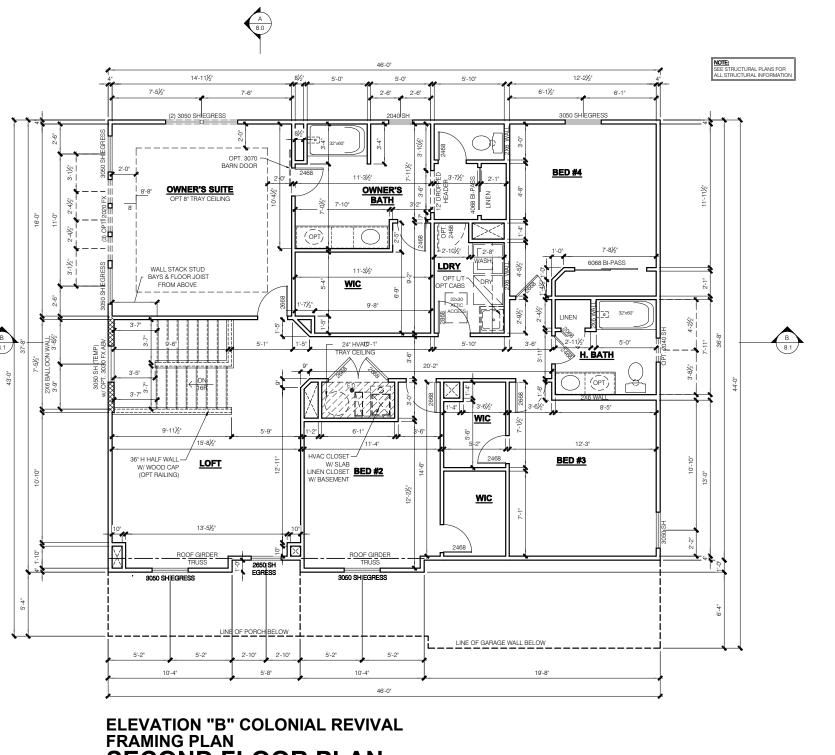

SECOND FLOOR PLAN

SCALE: 1/4" = 1'-0"

WINDOW/DOOR FRAMING NOTE:

WINDOW AND DOOR FRAMING TO INCLUDE (1) JACK STUD AND (1) KING STUD EA. SIDE U.N.O. SEE DETAILS 1 & 2 SHEET D3.1

GARAGE DRYWALL NOTE:

ALL GARAGE /HOUSE COMMON WALLS, CEILINGS, BEAMS, COLUMNS THAT SUPPORT FLOOR-CEILING ASSEMBLY ABOVE TO HAVE

%" DRYWALL WARM WALLS AND CEILING (UNFINISHED)

TYPICAL STUD WALL SIZES PER LOCATION:

GARAGE FINISH:

- EXTERIOR WALLS AT CONDITIONED SPACES ARE 2x6s W/ ½* NOMINAL SHEATHING U.N.O. (4*). STUDS @ 16* O.C. U.N.O. GAMBAGE/HOUSE COMMON WALLS ARE 2x6's U.N.O. (5½*) STUDS @ 24* O.C. U.N.O.
- GARAGE EXTERIOR WALLS ARE 2x6's W/ ½" NOMINAL SHEATHING U.N.O. (4") STUDS @ 16" O.C.
 - WALLS ADJACENT TO ATTIC SPACES ARE 2x4's W/ 2" NOMINAL SHEATHING U.N.O. (6"). **STUDS @ 16" O.C. U.N.O.**

EXTERIOR WALLS ARE SHOWN WITH 1/2 NOMINAL SHEATHING WHICH IS HELD FLUSH WITH THE OUTSIDE OF THE FOUNDATION

NOTE:

NO - INDICATES WALL HEIGHTS HIGHER
THAN STANDARD HEIGHT- AS NOTED - INDICATES SLOPED WALLS - AS NOTED - INDICATES INTERIOR LOAD BEARING WALLS, FRAME 16° O.C.(2x4) 24° O.C.(2x6) W/ DBL. TOP PLATE ALL OTHER WALLS ARE 9-1 1/8" HIGH ALL STRUCTURAL HEADERS ARE (2) 2x6 -UNLESS NOTED OTHERWISE. ALL POINT LOADS TO BE BLOCKED SOLID TO FINAL SUPPORT MEMBER OR Drake FINAL SET 4/08/20 PRINTS

SERIES **PRESTIGE**

ued Date: 03/2 BASE PLAN REVISION

Job #: LSP Date:

LSP By: SP Rev

neet Title

2nd Floor Plan

6.0B


X/X/XX

M/I

FOUNDATION. STAIRS FROM 1st TO 2nd FLOOR ARE TO BE

- INDICATES (3) JACK STUDS TYP. UNLESS NOTED (#2, SPF)

- INDICATES QUANTITY OF RIPPED LVL (2650 Fb-1.9E) or PSL STUDS, WIDE BY WALL THICKNESS

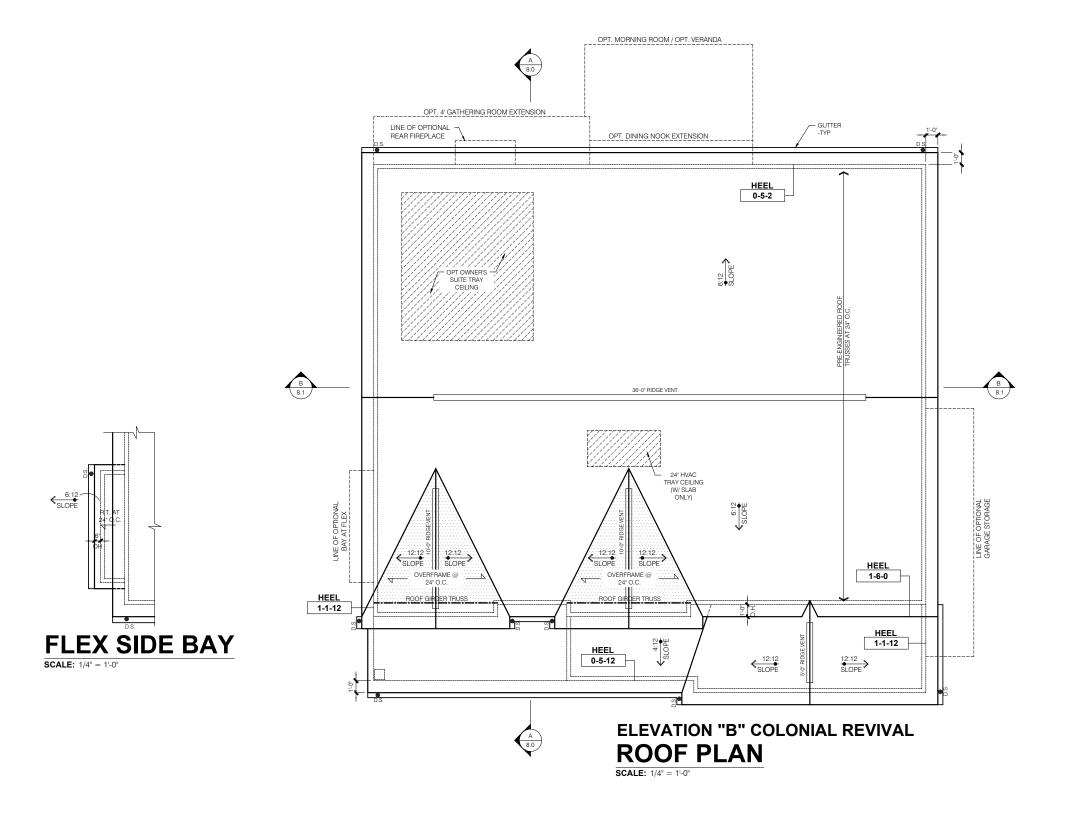

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- 2. TRUSS DRAWINGS STAMPED BY AN ENGINEER REGISTERED WITH THE STATE OF PERMIT, ALONG WITH LAYOUT SHEET, TO BE PROVIDED TO THE BUILDING INSPECTOR FOR FRAMING INSPECTION.
- 3. ALL TRUSS CONNECTIONS TO BE PROVIDED BY THE TRUSS MANUFACTURER.
- 4. "I"- JOIST RAFTER DESIGN BASED ON LPI 20PLUS (1.5E)
 I-JOISTS BY LOUISANA PACIFIC U.N.O.
- 5. ALL ROOF TRUSSES AND RAFTERS ARE TO BE CONNECTED TO DOUBLE TOP PLATE W/ A MINIMUM OF (1) H2.5A BY SIMPSON OR EQUAL U.N.O.
- G. GIRDER TRUSSES ARE TO HAVE HOLD DOWNS TO RESIST THE REQUIRED UPLIFT AS SHOWN ON TRUSS MANUFACTUER'S DRAWINGS.
- 7. ALL DIMENSIONAL LUMBER TO BE SYP #2 OR BETTER UNLESS NOTED OTHERWISE.

PRESTIGE SERIES

ASE PLAN REVISION

Drake FINAL SET 4/08/20


7 PRINTS ARE

Job #: ---LSP Date: X/X/XX
LSP By: BY
LSP Rev: ----

Sheet Title : Roof Plan - Base Roof

Sheet:

7.0B

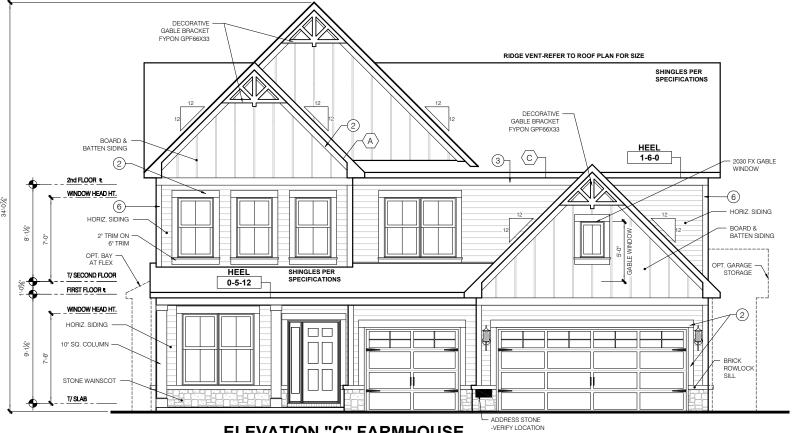

T/ SECOND FLOOR

HORIZ, SIDING

STONE WAINSCOT

OPT FLEX SIDE BAY

FRONT ELEVATION

ELEVATION "C" FARMHOUSE FRONT ELEVATION

ROCO FLAN FOR BIZE

SINNOLES PER
SPECIFICATIONS

AND THE PERMANALY

MINOCON INFO OFT

THE PERMANALY

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THE PERMANALY

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MORNING ROCM

OPT LORD ROCK

ROCK STORAGE

OPT LORD ROCK

OPT LORD ROCK

ROCK STORAGE

OPT LORD ROCK

TYPICAL EXTERIOR TRIM FINISH

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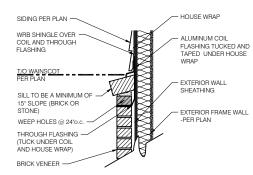
1 = 4" TRIM (1x4, 5/4x4, 3½" VINYL LINEAL)
2 = 6" TRIM (1x6, 5/4x6, 5" VINYL LINEAL)
3 = 8" TRIM (1x8, 5/4x8, 7" VINYL LINEAL)
4 = 10" TRIM
5 = 12" TRIM
6 FRONT CORNERS = 5"TRIM PER DIASION-SEE SPECS
DIVISION NOTE:

IT IS THE RESPONSIBILITY OF EACH DIVISION TO DETERMINE, AT A DIVISIONAL LEVEL AS WELL AS COMMUNITY SPECIFIC LEVEL, THE DESIRED FINISH REQUIREMENTS OF SPECIFIC TRIM PIECES; WHETHER PAINTED, VINYL, OR ALUMINUM WRAPPED.

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ELEVATION DEPICTED IS A
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BRICK WAINSCOT DETAIL

SERIES

PRESTIGE

Job #: ---LSP Date: X/X/XX
LSP By: BY
LSP Rev: ---Sheet Title :


Drake FINAL SET 4/08/20

Sheet Title :
Front And Garage
Elevations

Sheet:

1.0C

ELEVATION "C" FARMHOUSE
GARAGE SIDE ELEVATION

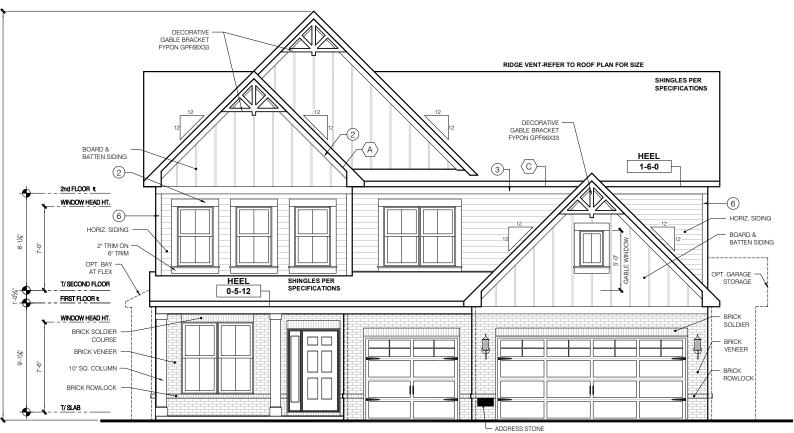

OPT FLEX SIDE BAY FRONT ELEVATION

SCALE: 1/4" = 1"-0"

WINDOW HEAD HT.

HORIZ. SIDING

10" SQ. COLUMN

STONE WAINSCOT

ELEVATION "C" FARMHOUSE FRONT ELEVATION W/ BRICK

TYPICAL EXTERIOR TRIM FINISH

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7 REAR CORNERS = 5"TRIM PER DIASION-SEE SPECS


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BRICK WAINSCOT DETAIL


PRESTIGE SERIES


Drake FINAL SET 4/08/20

Job #: ---LSP Date: X/X/XX
LSP By: BY
LSP Rev: --Sheet Title :
Front Elevation
Brick Garage

1.01C

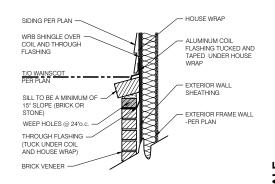heet.

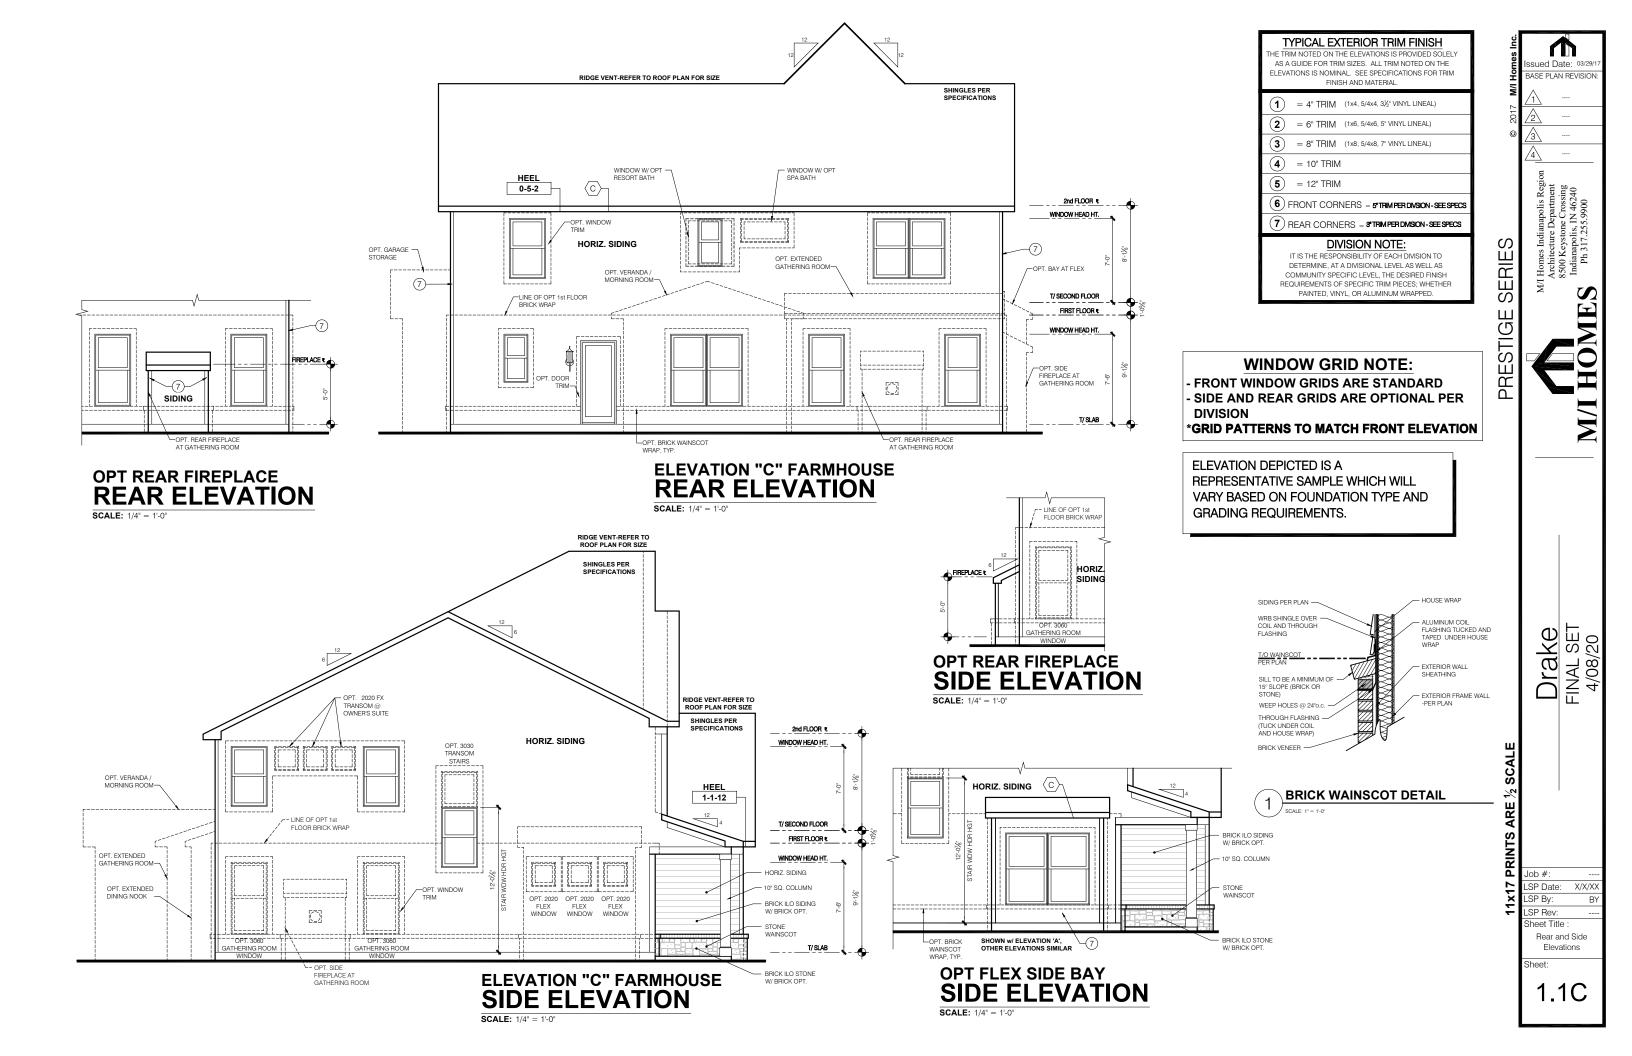

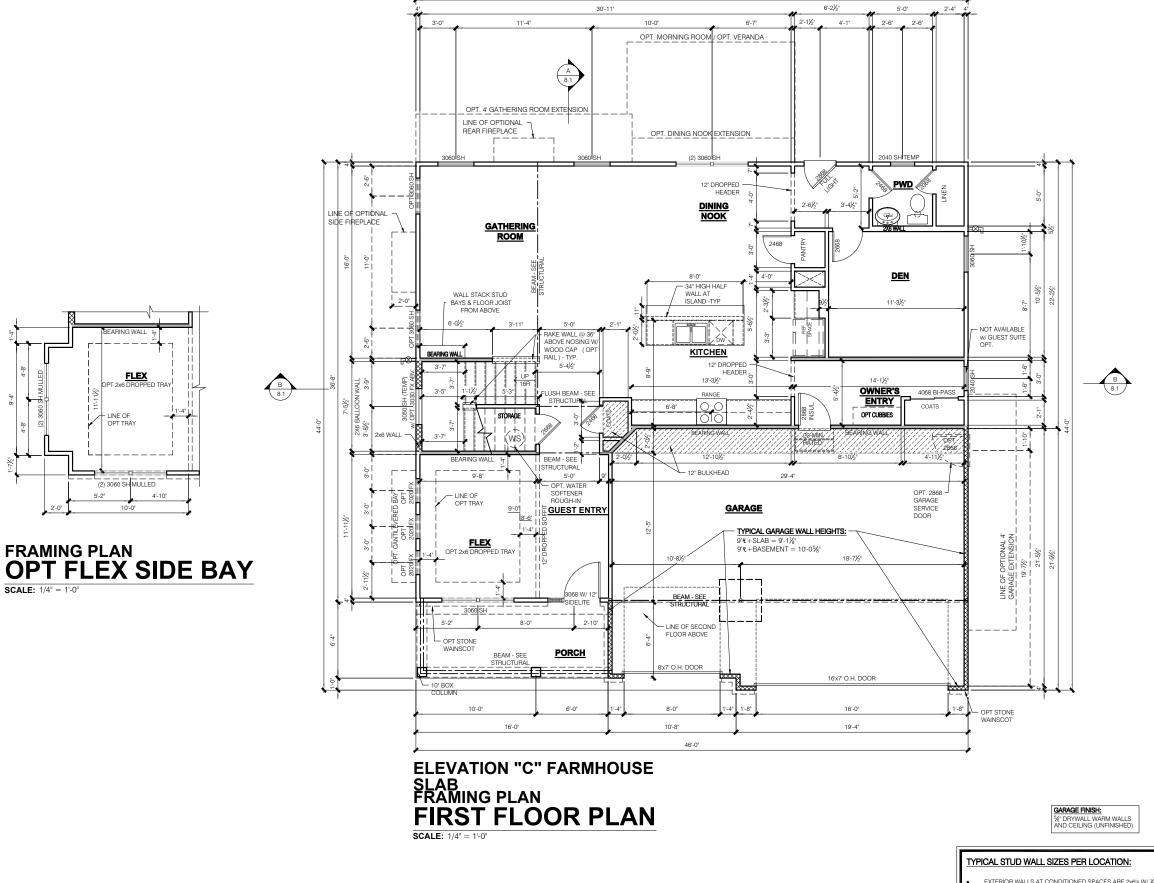

WINDOW/DOOR FRAMING NOTE:

WINDOW AND DOOR FRAMING TO INCLUDE (1) JACK

STUD AND (1) KING STUD EA. SIDE U.N.O.

SEE DETAILS 1 & 2 SHEET D3.1

- EXTERIOR WALLS AT CONDITIONED SPACES ARE 2x6's W/ ½* NOMINAL SHEATHING U.N.O. (4*). STUDS @ 16* O.C. U.N.O. GARAGE/HOUSE COMMON WALLS ARE 2x6's U.N.O. (5½*) STUDS @ 24* O.C. U.N.O.

GARAGE DRYWALL NOTE:

ALL GARAGE /HOUSE COMMON WALLS, CEILINGS, BEAMS, COLUMNS THAT SUPPORT FLOOR-CEILING ASSEMBLY ABOVE TO HAVE

- GARAGE EXTERIOR WALLS ARE 2x6's W/ ½" NOMINAL SHEATHING U.N.O. (4") STUDS @ 16" O.C. WALLS ADJACENT TO ATTIC SPACES ARE 2x4's W/ $\frac{1}{2}$ " NOMINAL SHEATHING U.N.O. (6"). STUDS @ 16" O.C. U.N.O.

EXTERIOR WALLS ARE SHOWN WITH $1/2^\circ$ NOMINAL SHEATHING WHICH IS HELD FLUSH WITH THE OUTSIDE OF THE FOUNDATION

SERIES

PRESTIGE

NOTE:
- INDICATES WALL HEIGHTS LOWER
THAN STANDARD HEIGHT- AS NOTE

- INDICATES WALL HEIGHTS HIGHER
THAN STANDARD HEIGHT- AS NOTED

- INDICATES INTERIOR LOAD BEARING WALLS, FRAME 16" O.C.(2x4) 24" O.C.(2x6) W/ DBL. TOP PLATE

ALL OTHER WALLS ARE 9-1 1/8" HIGH ALL STRUCTURAL HEADERS ARE (2) 2x6 -UNLESS NOTED OTHERWISE. ALL POINT LOADS TO BE BLOCKED SOLID TO FINAL SUPPORT MEMBER OR

STAIRS FROM 1st TO 2nd FLOOR ARE TO BE

INDICATES (3) JACK STUDS TYP.
 UNLESS NOTED (#2, SPF)

- INDICATES QUANTITY OF RIPPED LVL (2650 Fb-1.9E)or PSL STUDS, WIDE BY WALL THICKNESS

 $\begin{tabular}{ll} $\#$ \hline & - \text{INDICATES QUANTITY OF NON-STD.} \\ & \text{STUDS } (\#2 \text{ SPF}) \\ \end{tabular}$


- INDICATES SLOPED WALLS - AS NOTED

Job #: LSP Date: X/X/XX LSP By: SP Rev heet Title

1st Floor Plan - Slab

Drake FINAL SET 4/08/20

4.0C

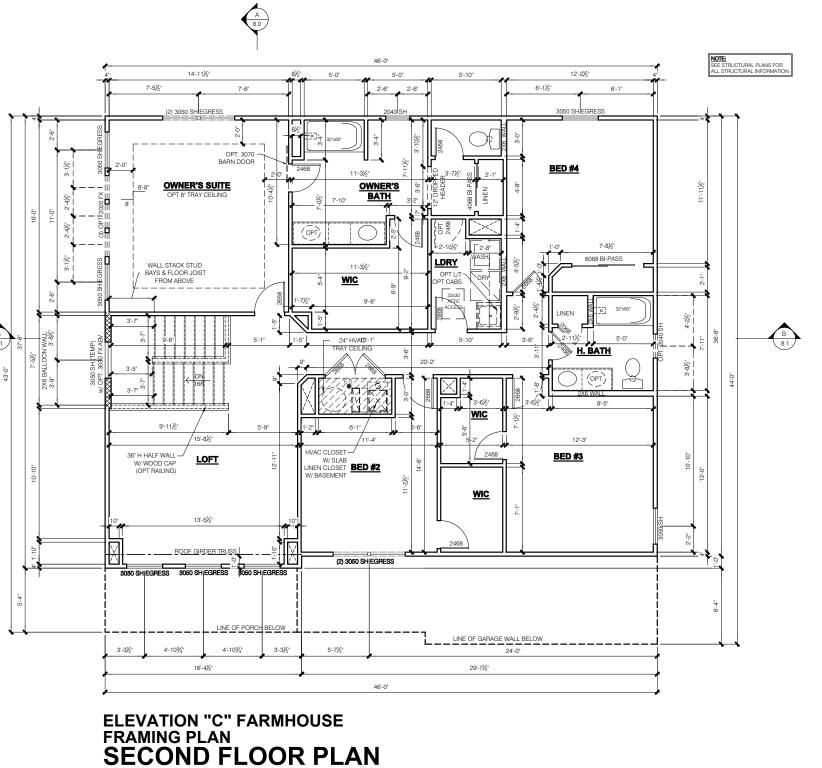

SCALE: 1/4" = 1'-0"

WINDOW/DOOR FRAMING NOTE:

WINDOW AND DOOR FRAMING TO INCLUDE (1) JACK STUD AND (1) KING STUD EA. SIDE U.N.O. SEE DETAILS 1 & 2 SHEET D3.1

GARAGE DRYWALL NOTE:

ALL GARAGE /HOUSE COMMON WALLS, CEILINGS, BEAMS, COLUMNS THAT SUPPORT FLOOR-CEILING ASSEMBLY ABOVE TO HAVE

TYPICAL STUD WALL SIZES PER LOCATION:

GARAGE FINISH: %" DRYWALL WARM WALLS AND CEILING (UNFINISHED)

- EXTERIOR WALLS AT CONDITIONED SPACES ARE 2x6s W/ ½* NOMINAL SHEATHING U.N.O. (4*). STUDS @ 16* O.C. U.N.O. GAMBAGE/HOUSE COMMON WALLS ARE 2x6's U.N.O. (5½*) STUDS @ 24* O.C. U.N.O.
- GARAGE EXTERIOR WALLS ARE 2x6's W/ ½" NOMINAL SHEATHING U.N.O. (4") STUDS @ 16" O.C.
- WALLS ADJACENT TO ATTIC SPACES ARE 2x4's W/ 2" NOMINAL SHEATHING U.N.O. (6"). **STUDS @ 16" O.C. U.N.O.**

EXTERIOR WALLS ARE SHOWN WITH 1/2 NOMINAL SHEATHING WHICH IS HELD FLUSH WITH THE OUTSIDE OF THE FOUNDATION

NOTE:
- INDICATES WALL HEIGHTS LOWER
THAN STANDARD HEIGHT- AS NOTE - INDICATES WALL HEIGHTS HIGHER
THAN STANDARD HEIGHT- AS NOTED - INDICATES SLOPED WALLS - AS NOTED

- INDICATES INTERIOR LOAD BEARING WALLS, FRAME 16° O.C.(2x4) 24° O.C.(2x6) W/ DBL. TOP PLATE
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- FOUNDATION. STAIRS FROM 1st TO 2nd FLOOR ARE TO BE 16 RISERS

- INDICATES (3) JACK STUDS TYP. UNLESS NOTED (#2, SPF)

- INDICATES QUANTITY OF RIPPED LVL (2650 Fb-1.9E) or PSL STUDS, WIDE BY WALL THICKNESS

Job #: LSP Date: LSP By:

X/X/XX SP Rev neet Title

Drake FINAL SET 4/08/20


BASE PLAN REVISION

SERIES

PRESTIGE

2nd Floor Plan

6.0C

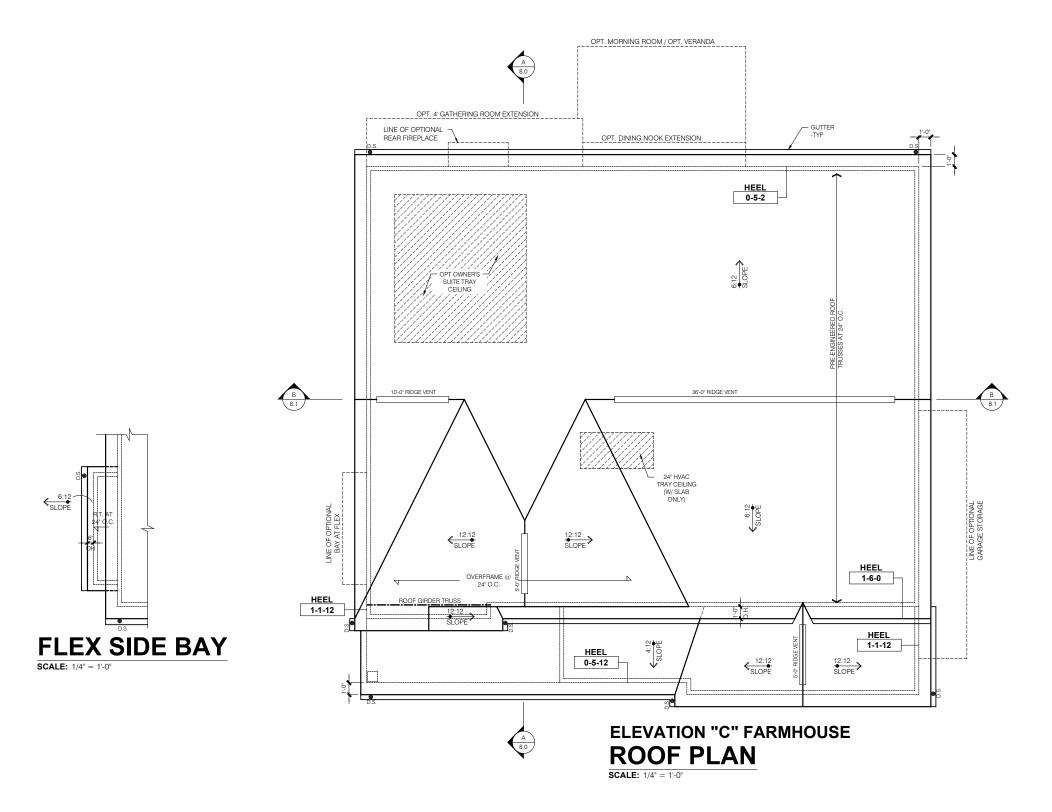

1. THIS LAYOUT REPRESENTS DESIGN INTENT ONLY.
SUPPLIER IS TO PROVIDE FINAL TRUSS LAYOUT AND ENGINEERED DRAWINGS FOR APPROVAL OF M/I HOMES.

- 2. TRUSS DRAWINGS STAMPED BY AN ENGINEER REGISTERED WITH THE STATE OF PERMIT, ALONG WITH LAYOUT SHEET, TO BE PROVIDED TO THE BUILDING INSPECTOR FOR FRAMING INSPECTION.
- 3. ALL TRUSS CONNECTIONS TO BE PROVIDED BY THE TRUSS MANUFACTURER.
- 4. "I"- JOIST RAFTER DESIGN BASED ON LPI 20PLUS (1.5E)
 I-JOISTS BY LOUISANA PACIFIC U.N.O.
- 5. ALL ROOF TRUSSES AND RAFTERS ARE TO BE CONNECTED TO DOUBLE TOP PLATE W/ A MINIMUM OF (1) H2.5A BY SIMPSON OR EQUAL U.N.O.
- GIRDER TRUSSES ARE TO HAVE HOLD DOWNS TO RESIST THE REQUIRED UPLIFT AS SHOWN ON TRUSS MANUFACTUERS DRAWINGS.
- 7. ALL DIMENSIONAL LUMBER TO BE SYP #2 OR BETTER UNLESS NOTED OTHERWISE.

PRESTIGE SERIES

ASE PLAN REVISION

Drake FINAL SET 4/08/20


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Job #: ---LSP Date: X/X/XX
LSP By: BY
LSP Rev: ----


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Sheet:


7.0C



OPT FLEX SIDE BAY FRONT ELEVATION

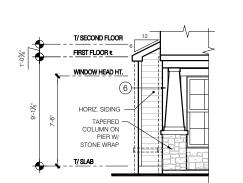


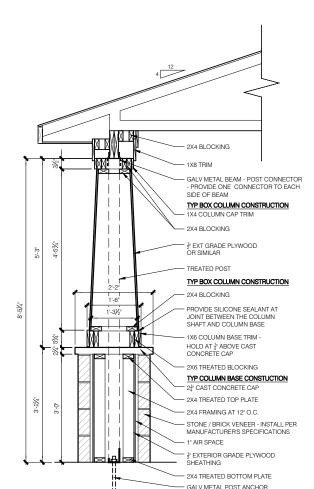TAPERED COLUMN ON PIER DETAIL

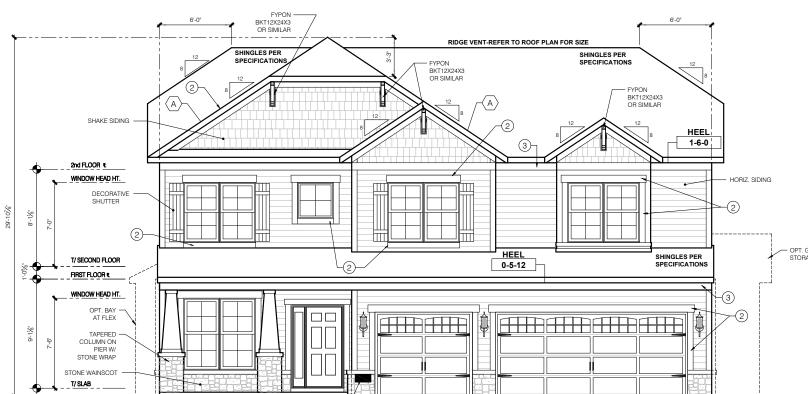

ELEVATION "D" CRAFTSMAN FRONT ELEVATION

SCALE: 1/4" = 1'-0"

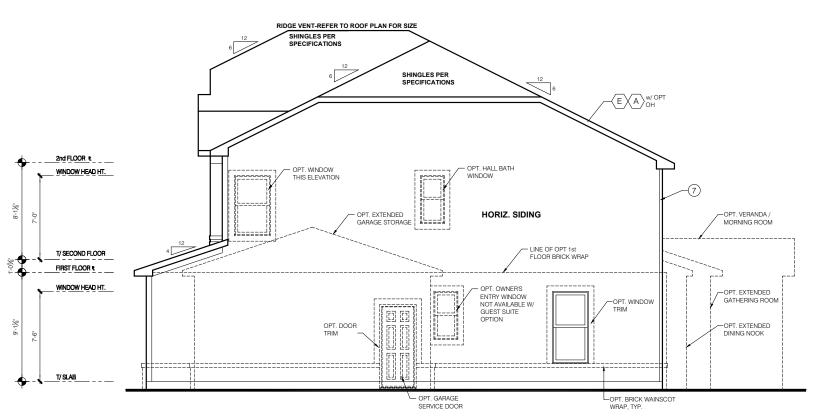

ELEVATION "D" CRAFTSMAN
GARAGE SIDE ELEVATION

TYPICAL EXTERIOR TRIM FINISH

THE TRIM NOTED ON THE ELEVATIONS IS PROVIDED SOLELY
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4 = 10" TRIM

= 12" TRIM

6 FRONT CORNERS = 5"TRIM PER DIVISION - SEE SPECS

(7) REAR CORNERS = 3"TRIM PER DIVISION - SEE SPECS


DIVISION NOTE

IT IS THE RESPONSIBILITY OF EACH DIVISION TO DETERMINE, AT A DIVISIONAL LEVEL AS WELL AS COMMUNITY SPECIFIC LEVEL, THE DESIRED FINISH REQUIREMENTS OF SPECIFIC TRIM PIECES; WHETHER PAINTED, VINYL, OR ALUMINUM WRAPPED.

WINDOW GRID NOTE:

- FRONT WINDOW GRIDS ARE STANDARD
 SIDE AND REAR GRIDS ARE OPTIONAL PER DIVISION
- *GRID PATTERNS TO MATCH FRONT ELEVATION

ELEVATION DEPICTED IS A
REPRESENTATIVE SAMPLE WHICH WILL
VARY BASED ON FOUNDATION TYPE AND
GRADING REQUIREMENTS.

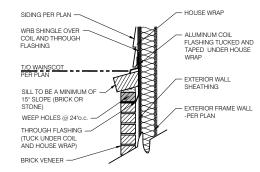

BRICK WAINSCOT DETAIL

SERIES

PRESTIGE

Job #: ---LSP Date: X/X/XX
LSP By: BY
LSP Rev: ---Sheet Title :

Drake FINAL SET 4/08/20

Sheet Title : Front And Garage Elevations

Sheet:

1.0D

SCALE: 3/4" = 1'-0"



SCALE: 1/4" = 1'-0"

OPT FLEX SIDE BAY
FRONT ELEVATION

T/ SLAB

T/ SECOND FLOOR

HORIZ. SIDING

TAPERED -COLUMN ON PIER W/ STONE WRAP

FIRST FLOOR €

SCALE: 1/4" = 1'-0"

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6 FRONT CORNERS = 5"TRIM PER DIVISION - SEE SPECS

(7) REAR CORNERS = 3°TRIM PER DMSION-SEE SPECS


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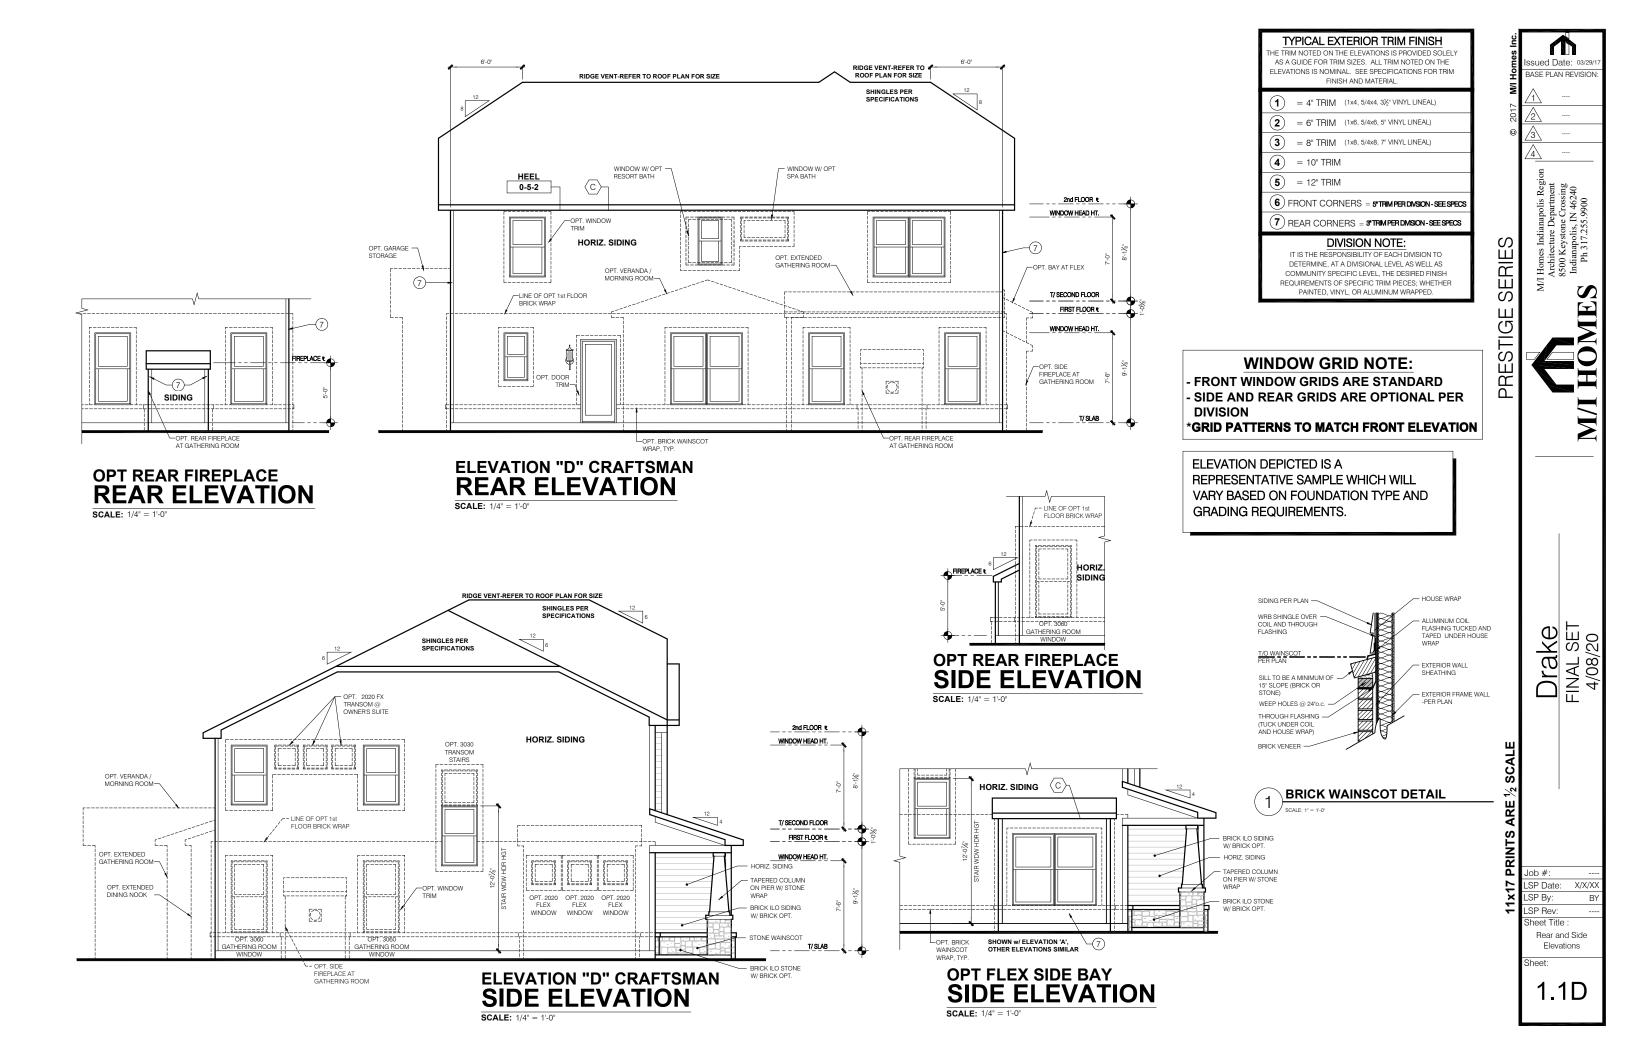
PRESTIGE SERIES


Drake FINAL SET 4/08/20

Job #: ---LSP Date: X/X/XX
LSP By: BY
LSP Rev: ---Sheet Title :
Front And Garage

1.0.1D

Elevations Brick

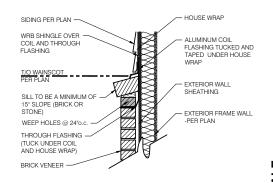

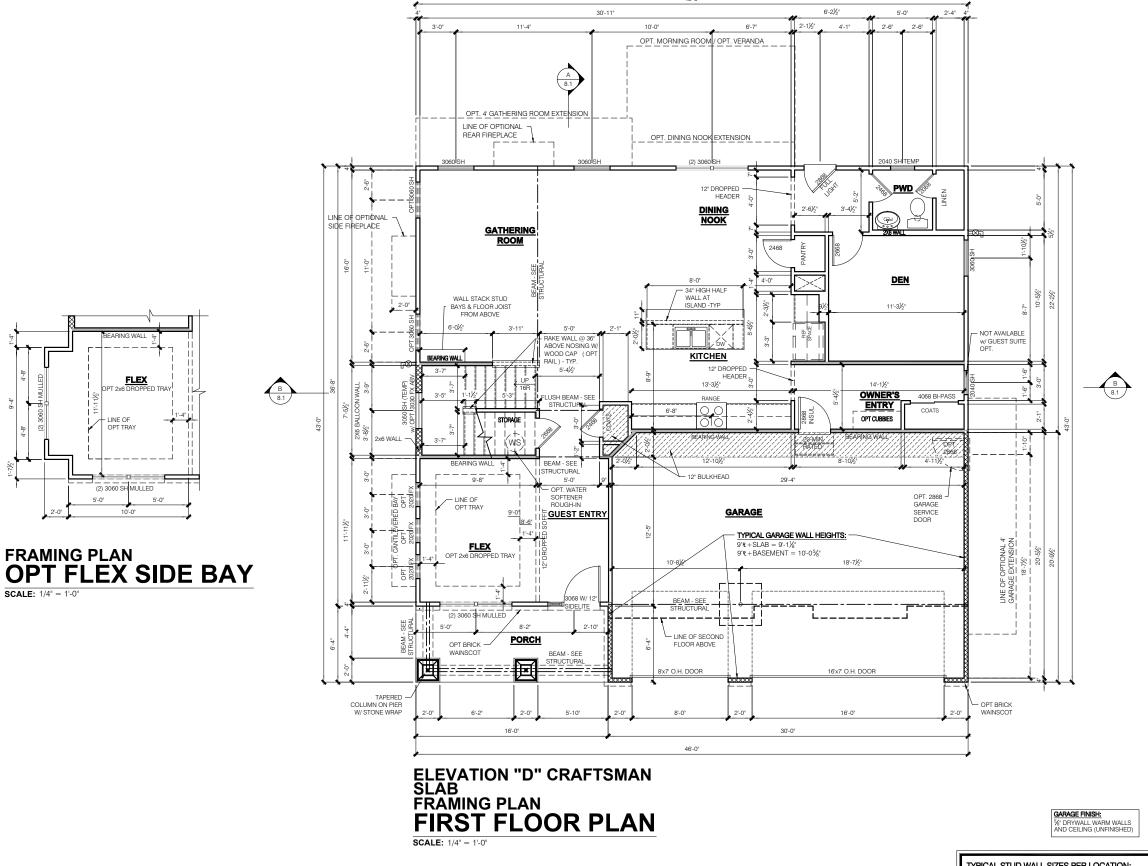

GARAGE DRYWALL NOTE:

WINDOW/DOOR FRAMING NOTE: WINDOW AND DOOR FRAMING TO INCLUDE (1) JACK STUD AND (1) KING STUD EA. SIDE U.N.O. SEE DETAILS 1 & 2 SHEET D3.1

ALL GARAGE /HOUSE COMMON WALLS, CEILINGS, BEAMS, COLUMNS THAT SUPPORT FLOOR-CEILING ASSEMBLY ABOVE TO HAVE

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SERIES

PRESTIGE

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 $\begin{tabular}{ll} $\#$ \hline & - \text{INDICATES QUANTITY OF NON-STD.} \\ & \text{STUDS } (\#2 \text{ SPF}) \\ \end{tabular}$

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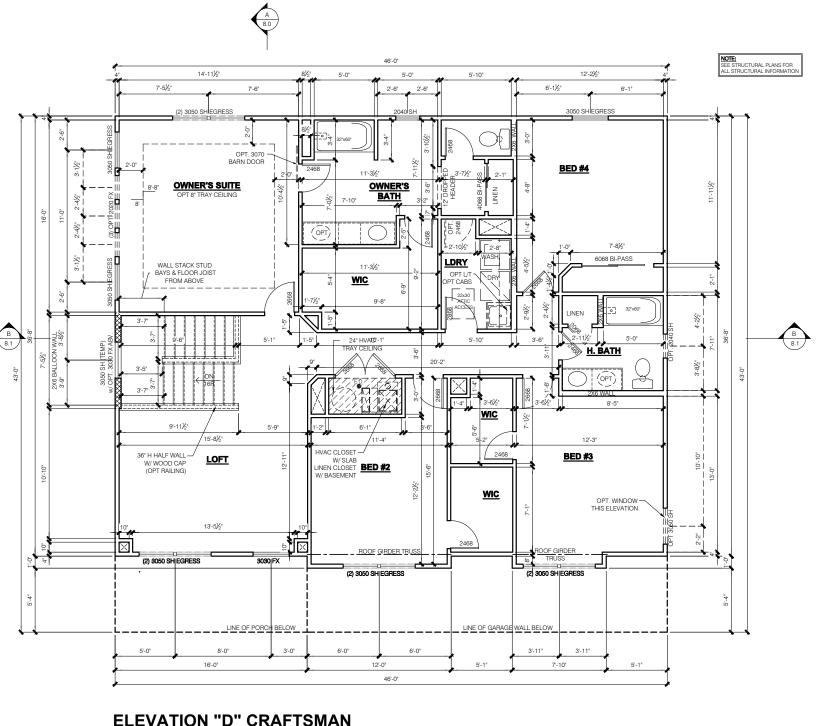
- INDICATES SLOPED WALLS - AS NOTED

Job #: LSP Date: X/X/XX LSP By: SP Rev heet Title

Drake FINAL SET 4/08/20

1st Floor Plan - Slab

4.0D



ELEVATION "D" CRAFTSMAN FRAMING PLAN
SECOND FLOOR PLAN

SCALE: 1/4" = 1'-0"

WINDOW/DOOR FRAMING NOTE:

WINDOW AND DOOR FRAMING TO INCLUDE (1) JACK STUD AND (1) KING STUD EA. SIDE U.N.O. SEE DETAILS 1 & 2 SHEET D3.1

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Job #:

LSP Date: X/X/XX LSP By: SP Rev neet Title

Drake FINAL SET 4/08/20


BASE PLAN REVISION

SERIES

PRESTIGE

2nd Floor Plan

6.0D

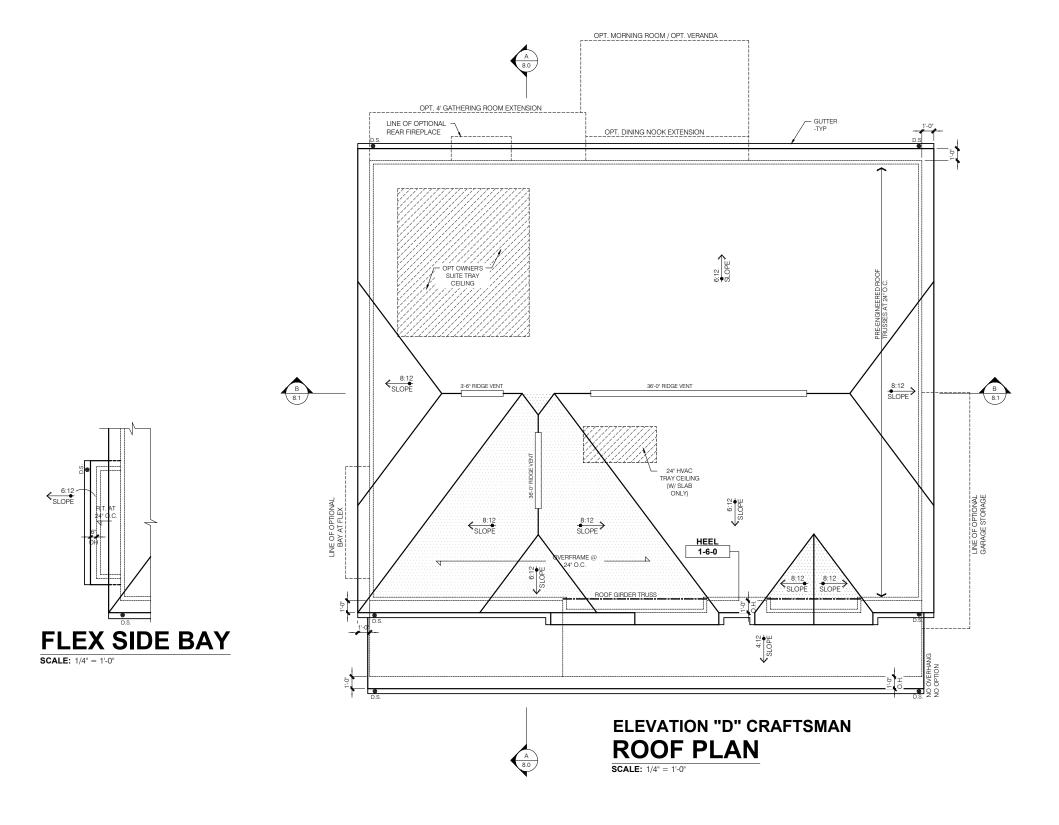

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PRESTIGE SERIES

ASE PLAN REVISION

Drake FINAL SET 4/08/20


7 PRINTS ARE

Job #: ---LSP Date: X/X/XX
LSP By: BY
LSP Rev: ----

Sheet Title : Roof Plan - Base Roof

Sheet:

7.0D

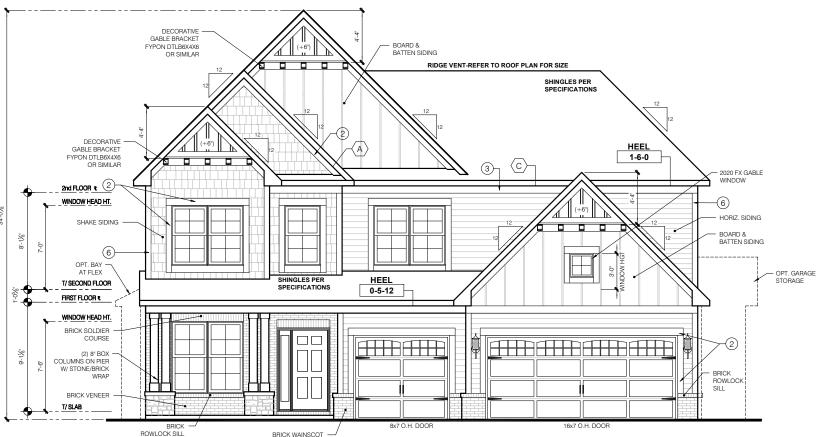

T/ SECOND FLOOR

BRICK BRICK

OPT FLEX SIDE BAY

FRONT ELEVATION

12" DIA. TAPERED

ELEVATION "E" ARTISAN FRONT ELEVATION

RIDGE VENT-REFER TO ROOF PLAN FOR SIZE SHINGLES PER SPECIFICATIONS EA OH HEEL 2-0-0 2nd FLOOR & WINDOW HEAD HT. 6 OPT. EXTENDED
GARAGE STORAGE 1-1-12 T/ SECOND FLOOR -OPT. EXTENDED GATHERING ROOM ENTRY WINDOW NOT AVAILABLE W/ OPT WINDOW $\langle E \rangle$ **GUEST SUITE** OPT, DOOR -OPT. EXTENDED OPT. BRICK WAINSCOT WRAP, TYP.

ELEVATION "E" ARTISAN
GARAGE SIDE ELEVATION

TYPICAL EXTERIOR TRIM FINISH

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(1x8, 5/4x8, 7° VINYL LINEAL) (4) = 10" TRIM

5 = 12" TRIM

(6) FRONT CORNERS = 5"TRIM PER DIVISION - SEE SPECS
(7) REAR CORNERS = 5"TRIM PER DIVISION - SEE SPECS


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WINDOW GRID NOTE:

- FRONT WINDOW GRIDS ARE STANDARD - SIDE AND REAR GRIDS ARE OPTIONAL PER DIVISION
- *GRID PATTERNS TO MATCH FRONT ELEVATION

ELEVATION DEPICTED IS A
REPRESENTATIVE SAMPLE WHICH WILL
VARY BASED ON FOUNDATION TYPE AND
GRADING REQUIREMENTS.



BRICK WAINSCOT DETAIL

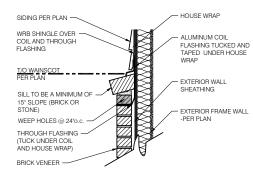SERIES


PRESTIGE

Job #: ---LSP Date: X/X/XX
LSP By: BY
LSP Rev: --Sheet Title:
Front And Garage

Drake FINAL SET 4/08/20

1.0E

Elevations

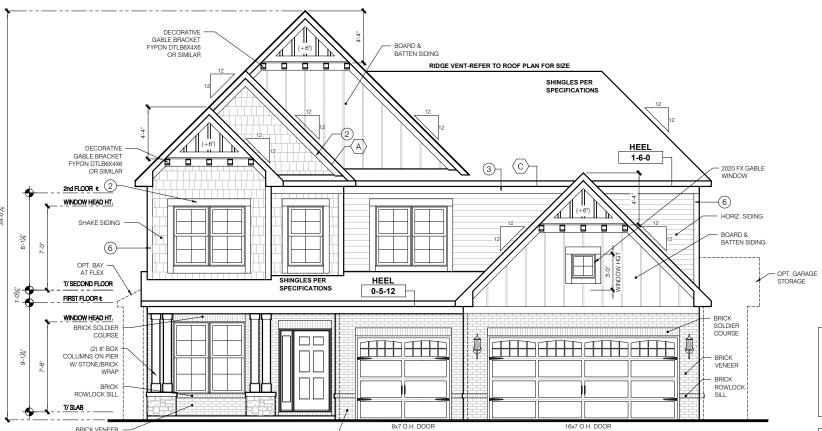

SCALE: 1/4" = 1'-0"

ELEVATION "E" ARTISAN FRONT ELEVATION

BRICK WAINSCOT -

T/ SECOND FLOOR

WINDOW HEAD HT.

12" DIA. TAPERED

T/ SLAB

SCALE: 1/4" = 1'-0"

COLUMN

OPT FLEX SIDE BAY

FRONT ELEVATION

FIRST FLOOR €

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TYPICAL EXTERIOR TRIM FINISH TRIM NOTED ON THE ELEVATIONS IS PROVIDED SOLELY

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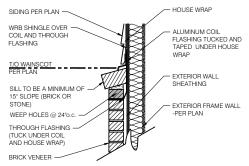
ELEVATIONS IS NOMINAL. SEE SPECIFICATIONS FOR TRIM


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Drake FINAL SET 4/08/20


SERIES


PRESTIGE

Job #: LSP Date: X/X/XX LSP By: LSP Rev heet Title

Front And Garage Elevations Brick

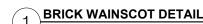1.0.1E

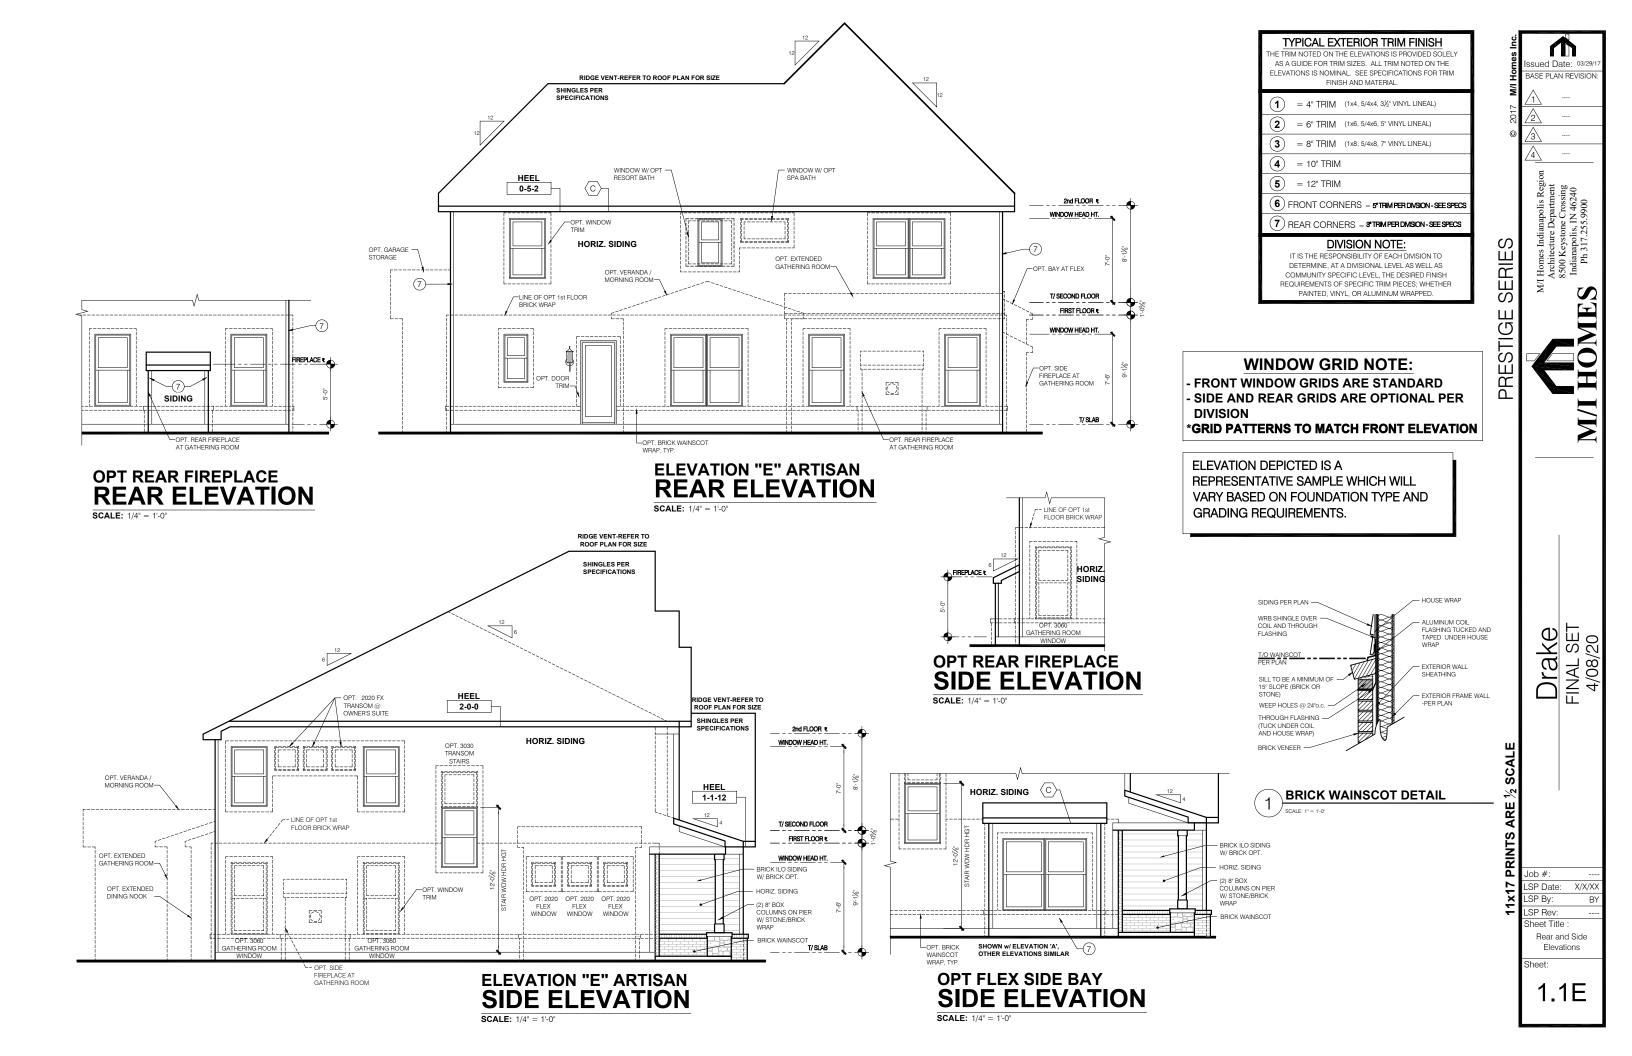

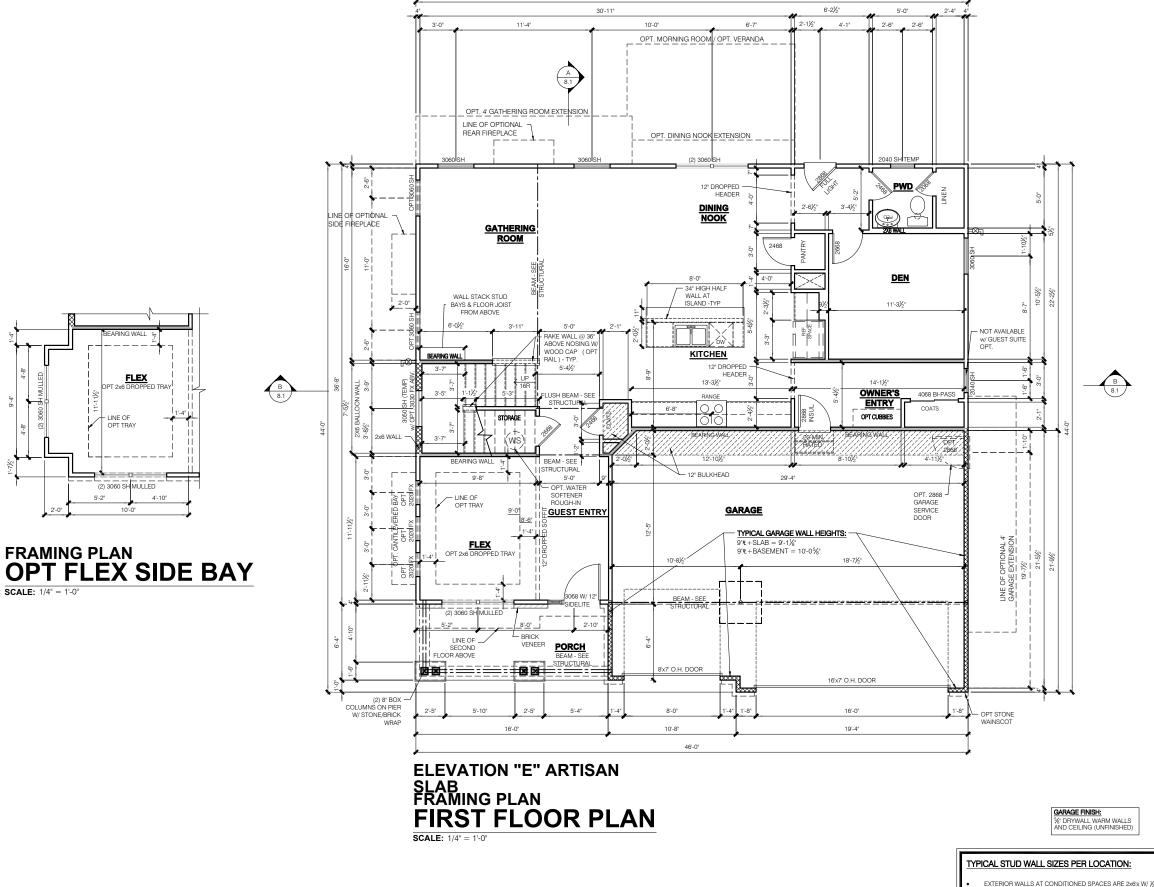

WINDOW/DOOR FRAMING NOTE:

WINDOW AND DOOR FRAMING TO INCLUDE (1) JACK

STUD AND (1) KING STUD EA. SIDE U.N.O.

SEE DETAILS 1 & 2 SHEET D3.1

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SERIES

PRESTIGE

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- INDICATES QUANTITY OF RIPPED LVL (2650 Fb-1.9E)or PSL STUDS, WIDE BY WALL THICKNESS

 $\begin{tabular}{ll} $\#$ \hline & - \text{INDICATES QUANTITY OF NON-STD.} \\ & \text{STUDS } (\#2 \text{ SPF}) \\ \end{tabular}$


- INDICATES SLOPED WALLS - AS NOTED

Job #: LSP Date: X/X/XX LSP By: SP Rev neet Title

1st Floor Plan - Slab

Drake FINAL SET 4/08/20

4.0E

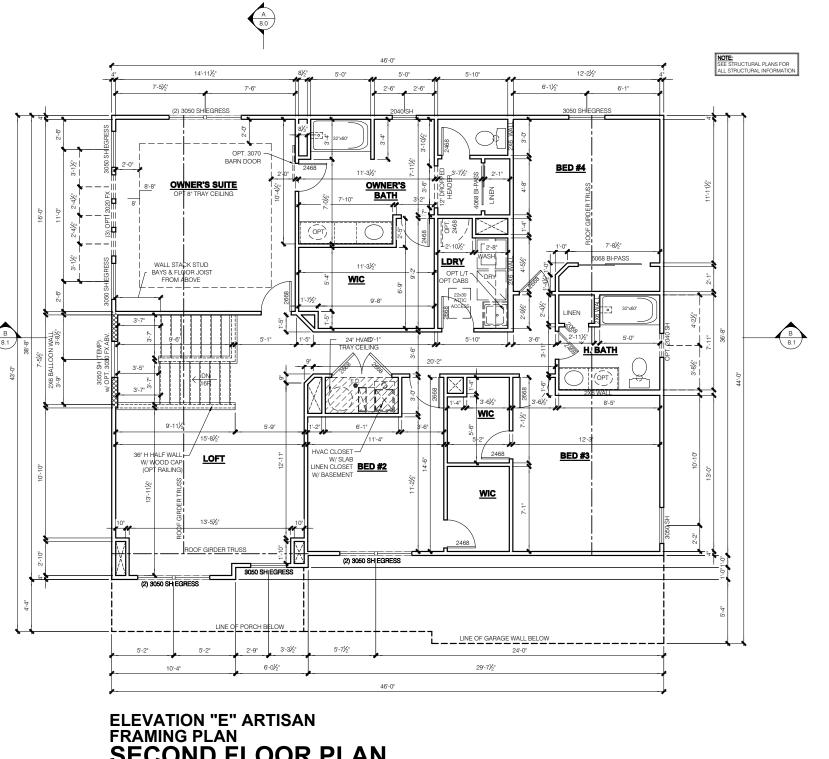

SECOND FLOOR PLAN

SCALE: 1/4" = 1'-0"

WINDOW/DOOR FRAMING NOTE:

WINDOW AND DOOR FRAMING TO INCLUDE (1) JACK STUD AND (1) KING STUD EA. SIDE U.N.O. SEE DETAILS 1 & 2 SHEET D3.1

GARAGE DRYWALL NOTE:

ALL GARAGE /HOUSE COMMON WALLS, CEILINGS, BEAMS, COLUMNS THAT SUPPORT FLOOR-CEILING ASSEMBLY ABOVE TO HAVE

%" DRYWALL WARM WALLS AND CEILING (UNFINISHED)

TYPICAL STUD WALL SIZES PER LOCATION:

GARAGE FINISH:

- EXTERIOR WALLS AT CONDITIONED SPACES ARE 2x6s W/ ½* NOMINAL SHEATHING U.N.O. (4*). STUDS @ 16* O.C. U.N.O. GAMBAGE/HOUSE COMMON WALLS ARE 2x6's U.N.O. (5½*) STUDS @ 24* O.C. U.N.O.
- GARAGE EXTERIOR WALLS ARE 2x6's W/ ½" NOMINAL SHEATHING U.N.O. (4") STUDS @ 16" O.C.
- WALLS ADJACENT TO ATTIC SPACES ARE 2x4's W/ 2" NOMINAL SHEATHING U.N.O. (6"). **STUDS @ 16" O.C. U.N.O.**

EXTERIOR WALLS ARE SHOWN WITH 1/2 NOMINAL SHEATHING WHICH IS HELD FLUSH WITH THE OUTSIDE OF THE FOUNDATION

NOTE:
- INDICATES WALL HEIGHTS LOWER
THAN STANDARD HEIGHT- AS NOTE - INDICATES WALL HEIGHTS HIGHER
THAN STANDARD HEIGHT- AS NOTED - INDICATES SLOPED WALLS - AS NOTED - INDICATES INTERIOR LOAD BEARING WALLS, FRAME 16° O.C.(2x4) 24° O.C.(2x6) W/ DBL. TOP PLATE ALL OTHER WALLS ARE 9-1 1/8" HIGH ALL STRUCTURAL HEADERS ARE (2) 2x6 -UNLESS NOTED OTHERWISE. ALL POINT LOADS TO BE BLOCKED SOLID TO FINAL SUPPORT MEMBER OR

FOUNDATION. STAIRS FROM 1st TO 2nd FLOOR ARE TO BE 16 RISERS

- INDICATES (3) JACK STUDS TYP. UNLESS NOTED (#2, SPF)

 $\begin{tabular}{ll} $\#$ \\ - INDICATES QUANTITY OF NON-STD.} \\ $\text{STUDS } (\#2\ \text{SPF}) \\ \end{tabular}$

- INDICATES QUANTITY OF RIPPED LVL (2650 Fb-1.9E) or PSL STUDS, WIDE BY WALL THICKNESS

PRINTS

Job #: LSP Date: X/X/XX LSP By: SP Rev neet Title

Drake FINAL SET 4/08/20


ued Date: 03/2 BASE PLAN REVISION

SERIES

PRESTIGE

2nd Floor Plan

6.0E

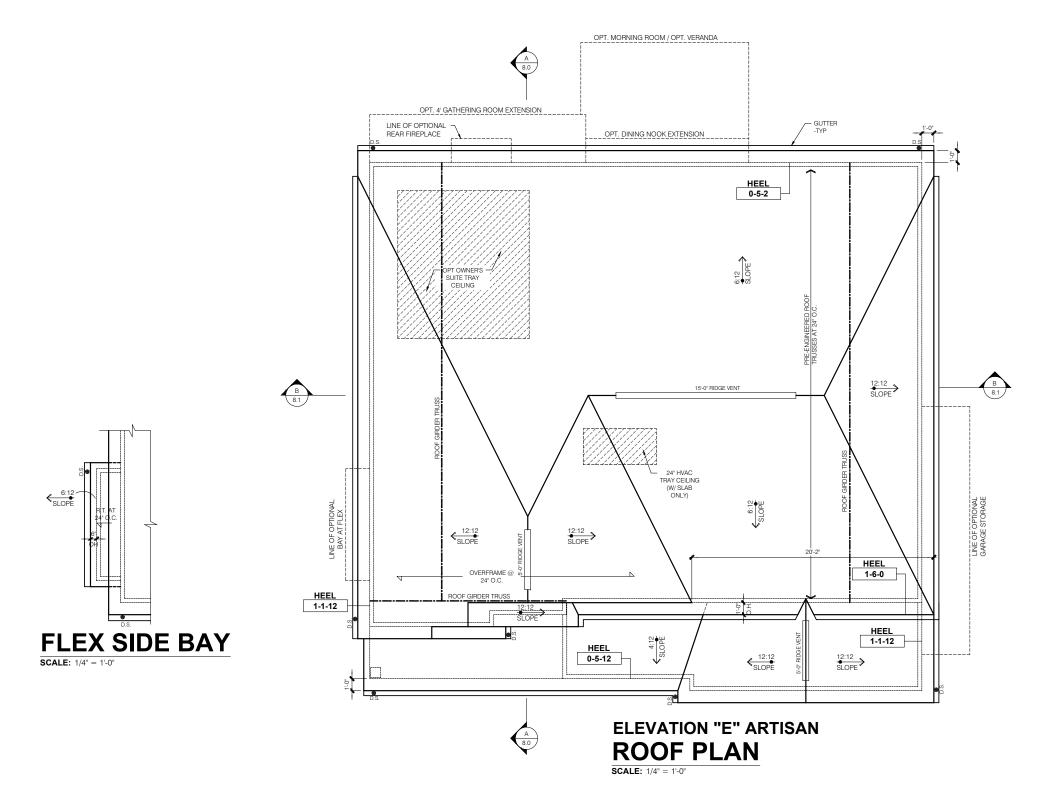

1. THIS LAYOUT REPRESENTS DESIGN INTENT ONLY.
SUPPLIER IS TO PROVIDE FINAL TRUSS LAYOUT AND ENGINEERED DRAWINGS FOR APPROVAL OF M/I HOMES.

- 2. TRUSS DRAWINGS STAMPED BY AN ENGINEER REGISTERED WITH THE STATE OF PERMIT, ALONG WITH LAYOUT SHEET, TO BE PROVIDED TO THE BUILDING INSPECTOR FOR FRAMING INSPECTION.
- 3. ALL TRUSS CONNECTIONS TO BE PROVIDED BY THE TRUSS MANUFACTURER.
- 4. "I"- JOIST RAFTER DESIGN BASED ON LPI 20PLUS (1.5E) I-JOISTS BY LOUISANA PACIFIC U.N.O.
- 5. ALL ROOF TRUSSES AND RAFTERS ARE TO BE CONNECTED TO DOUBLE TOP PLATE W/ A MINIMUM OF (1) H2.5A BY SIMPSON OR EQUAL U.N.O.
- GIRDER TRUSSES ARE TO HAVE HOLD DOWNS TO RESIST THE REQUIRED UPLIFT AS SHOWN ON TRUSS MANUFACTUERS DRAWINGS.
- 7. ALL DIMENSIONAL LUMBER TO BE SYP #2 OR BETTER UNLESS NOTED OTHERWISE.

PRESTIGE SERIES



ASE PLAN REVISION

Drake FINAL SET 4/08/20

7 PRINTS ARE

Job #: ---LSP Date: X/X/XX
LSP By: BY
LSP Rev: ----

Sheet Title : Roof Plan - Base Roof

Sheet:

7.0E